Received Date

Application Date

# LANCASTER COUNTY

555 SOUTH 10<sup>TH</sup> STREET LINCOLN, NE 68508

L.C.E.D. Utility Permit No.

Utility Company Project or WO No.

**Application to Construct** 

Utilities On County property

Lancaster County Contract No.

Only ONE type of Utility per permit.

County Rep.

Application is hereby made to LANCASTER COUNTY (" $\underline{\text{Count}}$ y") by:

Name of Utility Owner ("Owner"):

L.C.E.D. Maintenance District #

Address: Owner Phone:

Applicant Name: Applicant Phone:

Applicant Address: Applicant E-Mail: (If Not Same As Owner)

To construct or maintain a utility or utilities on County right-of-way as follows:

Please be as specific in you location as you can. Cross streets, Addresses, Subdivision Name with Lot & Block numbers, Section-Township-Range. **LOCATION OF WORK:** 

UTILITY TO BE CONSTRUCTED

TYPE DESCRIPTION ANNOTATION

PROPOSED UTILITY INSTALLATION

METHOD SIZE/WIDTH/
DIAMETER DESCRIPTION DEPTH/HEIGHT DESCRIPTION

NAME, ADDRESS, AND CONTACT NUMBER OF CONTRACTOR(S) ("Contractor(s)") PERFORMING THE WORK (if Applicable):

Ver. 7.3.5 05/24/2019 Page 1

### UTILITY PERMIT REQUIREMENTS

<u>NOTE:</u> If Engineer plan sheet project notes conflict with County's Utility Permit Application requirements and the Utility Permit Requirements, the Utility Permit Application Requirements and Utility Permit Requirements shall govern. An approved Utility Permit is required for all work being done in County right-of-way. See Page 6 for additional requirements upon permit approval.

- 1. Unless agreed to by County in writing, Owner/Contractor(s) shall meet the following Minimum Requirements:
  - A. Location of any and all utility installations parallel to the existing roadway are limited to the backslope area up to the existing road right-of-way line. New utility installations will NOT be allowed in the roadway, roadway shoulder, roadway foreslope and/or roadway ditch areas unless specific special instructions are given by the County and noted on the permit;
  - B. The depth to the top of the new utility installations shall be a minimum depth of 48 inches below the existing adjacent parallel roadway drainage ditch flowline, unless specific area depth instructions are allowed by County and noted on the permit;
  - C. In roadway fill sections with no backslope area within the road right-of-way area, the minimum depth to top of utility line shall be 48" from existing ground, unless specific special depth instructions are allowed by County and noted on the permit;
  - D. The minimum depth for burial beneath drainage structures, waterways, creek channels, or culverts within 5' of the utility route will be 72", as measured from the flow line of the drainage structure, waterway, or creek channel (whichever is lower), to the top of the utility;
  - E. No utility will be buried directly above a drainage structure, <u>regardless of the burial depth</u>;
  - F. All crossings with existing utilities will be separated by a minimum of 24";
  - G. All paved road and paved driveway crossings will be dry-bored;
  - H. All areas disturbed by construction will be restored to their pre-construction condition, including includes backfilling all open-cut crossings with material excavated from trench. No sand or crushed rock backfill will be allowed, and compaction of backfilled areas shall be at a density equal to or greater than the surrounding soil in and around trenches, bore pits, pull boxes, and other utility appurtenances. This section also requires the replacement of roadway and driveway surfacing lost or damaged by construction, and re-seeding of all areas disturbed by the work;
  - I. All trees, bushes, brush, debris piles, resulting from clearing or grubbing operations will become the property of the Owner/Contractor(s) and will be removed from County property at the Owner/Contractor(s) expense.
- 2. The Owner/Contractor(s) performing the work shall have on-site, a copy of approved Utility Permit allowing permitted work to be done within County Road Right-of-Way.
- 3. The Owner/Contractor(s) or their representative will mark all existing Lancaster County drainage structures along the proposed utility installation route 24 hours prior to construction at a culvert site. All structures will be marked in a manner so as to allow the Owner's Contractor(s) to identify all "Bore" locations. Owner/Contractor(s) shall furnish As-Built plans and submit area boring logs to document conformance with utility line depths.
- 4. The Owner/Contractor(s) will notify Lancaster County Maintenance Superintendent Ron Bohaty at 402-441-7797, a MINIMUM of 48 hours, prior to commencing construction on county right-of way.
- 5. Owner/Contractor(s) performing the work shall submit insurance conforming to the "Insurance Clause for Lancaster County Utility Permits," which is incorporated herein by this reference. Please note that "Insurance Clause for Lancaster County Utility Permits" requires, among other items, a certificate of insurance naming Lancaster County as additional insured on commercial general liability and auto policies, as well as a 30 day notice of cancelation, non-renewal or any material reduction of insurance coverage, prior to any activities in the County's right-of-wat. Please refer to the "Insurance Clause for Lancaster County Utility Permits" for full insurance requirements.
- 6. The Owner/Contractor(s) or their representative, shall contact the local utility companies and request location of any buried utilities. Damage to any utilities, either on County right-of-way or adjacent to County right-of-way, shall be repaired at the expense of the Owner/Contractor(s). In addition to any other indemnification obligations of Owner and Contractor(s), Owner and Contractor(s) by accepting and conducting work pursuant to this Utility Permit agree to indemnify, defend, and hold harmless the County, its elected officials, officers, employees, agents, consultants, and employees of any of them from and against claims, damages, losses and expenses, including but not limited to attorney fees, arising out of or resulting from Owner's or Contractor's(s') physical destruction or injury to utilities during Owner's or Contractor's(s') work pursuant to this Utility Permit, but only to the extent caused by the negligent, wrongful, or intentional acts or omissions of the Owner or Contractor(s), a subcontractor, anyone directly or indirectly employed by

them or anyone for whose acts they may be liable, regardless of whether or not such claim, damage, loss or expense is caused in part by the negligence of a party indemnified hereunder. Such obligation shall not be construed to negate, abridge, or reduce obligations of indemnity which would otherwise exist as to a party or person described in this paragraph. Nothing herein shall be construed to be a waiver of sovereign immunity by the County.

- 7. Future road construction work could necessitate relocation of utilities. Those utility relocation costs shall be borne by the Owner, and Owner's heirs, administrators, executors, legal and personal representatives, successors, and assigns.
- 8. All trenches shall be backfilled the same day trench was excavated except for the portion where the work is to be continued the next day. The portion left open for work continuation shall be protected by barricades with flashing lights at night. No open trenches in the roadway will be allowed overnight, except when such roadway is closed for construction, or except with prior conditional approval to be noted on page #6 of this document.
- 9. Roads may be closed for a maximum of 12 hours, with prior review and written approval from the County. (See #11 for signage layout)
- 10. Road closures longer than 12 hours will require prior review and written approval of the County, and a detour plan approved by the County. (See #11 for signage layout)
- 11. Three Type III barricades w/Type A flashing lights shall be placed on each side of construction site. "Road Closed" {R 1 1-2) signs shall be mounted on the middle barricade on each side of the construction site. At the nearest intersection each way from crossing, a "Road Close \_\_\_\_\_ Miles ahead -- Local Traffic Only" (R11-3) sign shall be placed.
- 12. All barricading, flagmen, warning signs, and other traffic control measures implemented pursuant to this Utility Permit shall conform to the current *Manual on Uniform Traffic Control Devices*.
- 13. No equipment shall be left unattended on public right-of-way. No trenches shall be left open after working hours. No equipment shall block traffic control devices.
- 14. All pipe and encasements shall conform to State Highway Standards.
- 15. All Right-of-Way and/or utility line control and staking shall be done by Owner/Contractor(s) and or their agents.
- 16. Upon completion of construction Owner/Contractor(s) shall provide the County with As-Built plans and submit boring logs to document utility depth and location.
- 17. Notification of proposed utility work to adjacent landowners shall be the responsibility of the Owner/Contractor(s).
- 18. A minimum 10 working day review for possible County Board approval, Board approval may add an additional 10-14 working days.
- 19. Owner/Contractor(s) shall be responsible to notify the County upon completion of permitted utility work.
- 20. <u>Failure to comply with the Utility Permit Requirements may result in revocation of this Utility Permit, and denial of future Utility Permits.</u>



Owner/Contractor(s) agrees to construct the stated utility in accordance with the Utility Permit Requirements as written herein. After final review and approval see "Additional Provisions" or "Special Requirements" as listed on page following signature sheets. Any "Additional Provisions" or "Special Requirements" as listed, will be enforced as a part of this Utility Permit. By signing this Application below, the individual signing on behalf of the Owner/Applicant hereby agrees and represents that he or she is legally capable to sign this Application and to lawfully bind the Owner to the terms and conditions of this Utility Permit. Approximate installation start date \_\_\_\_\_\_, Approximate installation completion date\_\_\_\_\_\_. OWNER/UTILITY: DATE: SIGNED BY OWNER/APPLICANT: Digital signatures ARE accepted. Please email form back to COENG@LANCASTER.NE.GOV **EXECUTION BY LANCASTER COUNTY** The above application is hereby approved subject to the requirements and provisions of the permit. APPROVED and dated this day of by the Lancaster County Board of Commissioners. LANCASTER COUNTY BOARD OF COMMISSIONERS Chairperson

**Deputy County Attorney** 

APPROVED as to form

REVIEWED this \_\_\_\_day of \_\_\_\_\_, \_\_\_\_\_,

this day of

Owner/Contractor(s) agrees to construct the stated utility in accordance with the Utility Permit Requirements as written herein. After final review and approval see "Additional Provisions" or "Special Requirements" as listed on page following signature sheets. Any "Additional Provisions" or "Special Requirements" as listed, will be enforced as a part of this Utility Permit.

By signing this Application below, the individual signing on behalf of the Owner/Applicant hereby agrees and represents that he or she is legally capable to sign this Application and to lawfully bind the Owner to the terms and conditions of this Utility Permit.

Approximate installation start date	, Approximate installation completion date
OWNER/UTILITY:	
Date:	
SIGNED BY OWNER/APPLICANT:	XV.
	tures ARE accepted. COENG@LANCASTER.NE.GOV
EXECU	TION BY LANCASTER COUNTY
The above application is hereby appro	oved subject to the requirements and provisions of the permit.
Date  Lancaster County Repr	resentative
is'	

# "Additional Provisions" or "Special Requirements" (TO BE FILLED IN BY COUNTY PERSONNEL)

Encasement Requirements:
Barricade, Signing and Flagging Requirements:
Methods of Installation:
Minimum Cover Provided in Road Ditches:
Willimum Cover Provided in Road Ditches.
Other Requirements:
Additional Comments:

# INSURANCE CLAUSE FOR LANCASTER COUNTY ENGINEER UTILITY PERMITS

# 1. Insurance; Coverage Information

The Contractor agrees that it shall, prior to beginning work pursuant to this Utility Permit, have, maintain, and provide proof of insurance coverage in a form satisfactory to the County and fulfilling all obligations set forth in this Insurance Clause. The County shall not withhold approval unreasonably. The coverages and minimum levels required by this Utility Permit are set forth herein and shall be in effect at all times that work is being done pursuant to this Utility Permit. No work pursuant to this Utility Permit shall begin until all insurance obligations herein are met to the satisfaction of the County. Self-insurance shall not be permitted unless written consent is given by the County prior to execution of the Utility Permit and may require submission of financial information for analysis. Deductible levels shall be provided in writing from the Contractor's insurer and will be no more than \$25,000.00 per occurrence. Said insurance shall be written on an OCCURRENCE basis, and shall be PRIMARY, with any insurance coverage maintained by the County being secondary or excess.

## 2. Certificates

The Contractor shall provide certificates of insurance and endorsements evidencing compliance with these requirements. The Contractor shall provide a Certificate of Insurance demonstrating the coverage required herein and the necessary endorsements and waivers described herein and below before being permitted to begin the work or project pursuant to this Utility Permit. All certificates, endorsements and endorsement forms (where required) must be acceptable to the County. Certificates shall include an endorsement to provide for at least thirty (30) days' firm written notice in the event of cancellation. During the term of the Utility Permit and during the period of any required continuing coverages, the Contractor shall provide, prior to expiration of the policies, certificates and endorsement forms evidencing renewal insurance coverages. The parties agree that the failure of County to object to the form of a certificate and/or additional insured endorsement or endorsement forms provided shall not constitute a waiver of this requirement.

# 3. Commercial General Liability

The Contractor shall have, maintain, and provide proof of Commercial General Liability Insurance with a minimum limit of not less than \$1,000,000.00 each occurrence and \$2,000,000.00 aggregate. These minimum limits can be met by primary and umbrella liability policies. Coverage shall include: Premises-Operations, Products/ Completed Operations, Contractual, Broad Form Property Damage, and Personal Injury. Such coverage shall be endorsed for the general aggregate to be on a **PER PROJECT** basis. The required insurance must include coverage for all projects and operations of Contractor or similar language that meets the approval of the County, which approval shall not be unreasonably withheld.

### 3.1 Automobile Liability

The Contractor shall have, maintain, and provide proof of Automobile Liability coverage, which shall include: Owned, Hired and Non-Owned. Bodily Injury and Property Damage Combined Single Limit shall be at least \$1,000,000 Per Accident.

# 3.2 Additional Insured (Requires an Endorsement Form)

Contractor shall add County as an Additional Insured, and shall provide an Additional Insured Endorsement Form showing the County as Additional Insured, on Contractor's Commercial General Liability policy and Contractor's Automobile policy.

# 3.3 Intentionally Omitted

# 3.4. Workers' Compensation; Employers' Liability

The Contractor shall have, maintain, and provide proof of workers' compensation insurance of not less than minimum statutory requirements under the laws of the State of Nebraska and any other applicable State. Employers' Liability coverage with limits of not less than \$500,000.00 each accident or injury shall be included. The Contractor shall provide the County with an endorsement for waiver of subrogation. The contractor shall also be responsible for ensuring that all subcontractors have workers' compensation insurance for their employees before and during the time any work is done pursuant to this Utility Permit.

# 3.5 Intentionally Omitted

# 3.5.1 Intentionally Omitted

# 3.6 Intentionally Omitted

# 3.7 Intentionally Omitted

# **3.8** Railroad Contractual Liability Insurance (Required only if appropriate)

If work is to be performed within 50 feet of any railroad property and affecting any railroad bridge or trestle, tracks, road beds, tunnel, underpass or railroad crossing, the Contractor must have, maintain, and provide a copy of an endorsement (ISO® form CG24170193 or newer) that removes or deletes any exception for such work in the Contractor's commercial general liability policy. Any endorsement not described herein shall be subject to the approval of the County.

# **3.8.1** Railroad Protective Liability (Required only if appropriate)

If work is to be performed within 50 feet of any railroad property and affecting any railroad bridge or trestle, tracks, road beds, tunnel, underpass or crossing or otherwise required by the Special Provisions or applicable requirements of an affected railroad, the Contractor shall have, maintain, and provide proof of Railroad Protective Liability Insurance naming the affected railroad/s as insured with minimum limits for bodily injury and property damage of \$2,000,000 per occurrence, \$6,000,000 aggregate, or such other limits as required in the Special Provisions or by the affected railroad. The original of the policy shall be furnished to the railroad and a certified copy of the same furnished to the County Engineer prior to any related construction or entry upon railroad premises by the Contractor or for work related to the Utility Permit.

# 3.9 <u>Intentionally Omitted</u>

# 4. Risk of Loss

Except to the extent covered by the Contractor's builder's risk insurance, the Contractor shall have the sole responsibility for the proper storage and protection of, and assumes all risk of loss of, any Subcontractor's Work and tools, materials, equipment, supplies, facilities, offices and other property at or off the project site. The Contractor shall be solely responsible for ensuring each subcontractor shall take every reasonable precaution in the protection of all structures, streets, sidewalks, materials and work of other subcontractors. Contractor shall protect its Work from damage by the elements or by other trades working in the area.

# 5. Umbrella or Excess Liability

The Contractor may use an Umbrella, Excess Liability, or similar coverage to supplement the primary insurance stated above in order to meet or exceed the

minimum coverage levels required by this Utility Permit.

# 6. <u>Minimum Scope of Insurance</u>

All Liability Insurance policies shall be written on an "Occurrence" basis only. All insurance coverage are to be placed with insurers authorized to do business in the State of Nebraska and must be placed with an insurer that has an A.M. Best's Rating of no less than A:VII unless specific written approval has been granted otherwise.

# 7. Indemnification

To the fullest extent permitted by law the Contractor shall indemnify, defend, and hold harmless the County, its elected officials, officers, employees, agents, consultants, and employees of any of them from and against any and all claims, damages, losses and expenses, including but not limited to attorney fees, arising out of or resulting from performance under this Utility Permit, including claims, damages, losses and expenses arising out of, but not limited to, claims, damages, losses and expenses for deprivations of civil rights, bodily injury, sickness, disease or death, or to injury to or destruction of tangible or intangible property, but only to the extent caused by the negligent, wrongful, or intentional acts or omissions of the Contractor, a subcontractor, anyone directly or indirectly employed by them or anyone for whose acts they may be liable, regardless of whether or not such claims, damages, losses or expenses are caused in part by the negligence of a party indemnified hereunder. Such obligation shall not be construed to negate, abridge, or reduce obligations of indemnity which would otherwise exist as to a party or person described in this paragraph. Nothing herein shall be construed to be a waiver of sovereign immunity by the County.

# 8. Reservation of Rights

The County reserves the right to require a higher limit of insurance or additional coverages when the County determines that a higher limit or additional coverage is required to protect the County or the interests of the public.

### 9. Sovereign Immunity

Nothing contained in this Insurance Clause or any other clauses, provisions, documents, attachments, or other portions of the Utility Permit shall be construed to waive the Sovereign Immunity of the County.



AFINLAY



# CERTIFICATE OF LIABILITY INSURANCE

DATE (MM/DD/YYYY) 6/27/2019

THIS CERTIFICATE IS ISSUED AS A MATTER OF INFORMATION ONLY AND CONFERS NO RIGHTS UPON THE CERTIFICATE HOLDER. THIS CERTIFICATE DOES NOT AFFIRMATIVELY OR NEGATIVELY AMEND, EXTEND OR ALTER THE COVERAGE AFFORDED BY THE POLICIES BELOW. THIS CERTIFICATE OF INSURANCE DOES NOT CONSTITUTE A CONTRACT BETWEEN THE ISSUING INSURER(S), AUTHORIZED REPRESENTATIVE OR PRODUCER. AND THE CERTIFICATE HOLDER.

IMPORTANT: If the certificate holder is an ADDITIONAL INSURED, the policy(ies) must have ADDITIONAL INSURED provisions or be endorsed. If SUBROGATION IS WAIVED, subject to the terms and conditions of the policy, certain policies may require an endorsement. A statement on this certificate does not confer rights to the certificate holder in lieu of such endorsement(s).

and commonte accessors rights to the common notices in how or				
PRODUCER	CONTACT Andrea Finlay			
Fee Insurance Group, Inc. P.O. Box 976	PHONE (A/C, No, Ext): (620) 259-8812 FAX (A/C, No):			
1 N. Main, Suite 700	E-MAIL ADDRESS: andrea@feeinsurance.com			
Hutchinson, KS 67501	INSURER(S) AFFORDING COVERAGE		NAIC #	
	INSURER A: Union Insurance Company		25844	
INSURED	INSURER B : Amerisafe American Interstate Insuran	ce Company	31895	
T3 Wireless, Inc	INSURER C: Columbia Casualty Company		31127	
220 W Main St	INSURER D : Federal Insurance Company		20281	
Council Grove, KS 66846	INSURER E:			
	INSURER F:			

COVERAGES CERTIFICATE NUMBER: REVISION NUMBER:

THIS IS TO CERTIFY THAT THE POLICIES OF INSURANCE LISTED BELOW HAVE BEEN ISSUED TO THE INSURED NAMED ABOVE FOR THE POLICY PERIOD INDICATED. NOTWITHSTANDING ANY REQUIREMENT, TERM OR CONDITION OF ANY CONTRACT OR OTHER DOCUMENT WITH RESPECT TO WHICH THIS CERTIFICATE MAY BE ISSUED OR MAY PERTAIN, THE INSURANCE AFFORDED BY THE POLICIES DESCRIBED HEREIN IS SUBJECT TO ALL THE TERMS, EXCLUSIONS AND CONDITIONS OF SUCH POLICIES. LIMITS SHOWN MAY HAVE BEEN REDUCED BY PAID CLAIMS.

INSR	TYPE OF INSURANCE	ADDL	SUBR		POLICY EFF	POLICY EXP (MM/DD/YYYY)	LIMIT	'S
A	X COMMERCIAL GENERAL LIABILITY	INOD			(MINICOTT TT)	(MINIO D) 1 1 1 1 1	EACH OCCURRENCE	\$ 1,000,00
	CLAIMS-MADE X OCCUR	Х	X	RUP3225145	6/16/2019	6/16/2020	DAMAGE TO RENTED PREMISES (Ea occurrence)	\$ 300,00
	X XCU						MED EXP (Any one person)	10,00
							PERSONAL & ADV INJURY	\$ 1,000,00
	GEN'L AGGREGATE LIMIT APPLIES PER:						GENERAL AGGREGATE	\$ 2,000,00
	X POLICY X PRO- X LOC						PRODUCTS - COMP/OP AGG	\$ 2,000,00
	OTHER:							\$
Α	AUTOMOBILE LIABILITY						COMBINED SINGLE LIMIT (Ea accident)	\$ 1,000,00
	X ANY AUTO	Х	X	RUP3225145	6/16/2019	6/16/2020	BODILY INJURY (Per person)	\$
	OWNED SCHEDULED AUTOS						BODILY INJURY (Per accident)	\$
	HIRED NON-OWNED AUTOS ONLY						PROPERTY DAMAGE (Per accident)	\$
								\$
Α	X UMBRELLA LIAB X OCCUR						EACH OCCURRENCE	\$ 5,000,00
	EXCESS LIAB CLAIMS-MADE	X	X	RUP3225145	6/16/2019	6/16/2020	AGGREGATE	\$ 5,000,00
	DED X RETENTION \$ 10,000							\$
В	WORKERS COMPENSATION AND EMPLOYERS' LIABILITY						X PER OTH- STATUTE ER	
	ANY PROPRIETOR/PARTNER/EXECUTIVE Y/N	N/A	X	AVWCIA2807792019	6/29/2019	6/16/2020	E.L. EACH ACCIDENT	\$ 1,000,00
	(Mandatory in NH)	117.7					E.L. DISEASE - EA EMPLOYEE	
	If yes, describe under DESCRIPTION OF OPERATIONS below						E.L. DISEASE - POLICY LIMIT	
С	Errors & Omissions			CEO591930812	6/16/2019	6/16/2020	Agg/Claim	2,000,00
D	Crime			8259-7311	6/16/2019	6/16/2020	Agg (Incl 3rd Party)	1,000,00

DESCRIPTION OF OPERATIONS / LOCATIONS / VEHICLES (ACORD 101, Additional Remarks Schedule, may be attached if more space is required)
As required by written contract, certificate holder and it's subsidiaries are primary & non-contributory additional insured per blanket on the general liability (including completed operations) & auto liability. As required by written contract & to the extent permitted by law, subrogation shall be waived on the general liability, auto liability & workers' compensation policies. Umbrella is follow form and is in excess of the general liability, auto liability, and workers' compensation. 30 days notice of cancellation (except 10 day notice for non-payment of premium) exists. All owners are included on Workers Compensation.

CERTIFICATE HOLDER	CANCELLATION
Lancaster County 555 South 10th St Lincoln. NE 68528	SHOULD ANY OF THE ABOVE DESCRIBED POLICIES BE CANCELLED BEFORE THE EXPIRATION DATE THEREOF, NOTICE WILL BE DELIVERED IN ACCORDANCE WITH THE POLICY PROVISIONS.
Lincolli, NE 00320	AUTHORIZED REPRESENTATIVE
	andrea J. Finlay

# ADDITIONAL INSURED – DESIGNATED PERSON OR ORGANIZATION

This endorsement modifies insurance provided under the following:

COMMERCIAL GENERAL LIABILITY COVERAGE PART

### **SCHEDULE**

Name Of Additional Insured Person(s) Or Organization(s):		
Lancaster County 555 South 10th St Lincoln, NE 68528		
Information required to complete this Schedule, if not shown above, will be shown in the Declarations.		

- A. Section II Who Is An Insured is amended to include as an additional insured the person(s) or organization(s) shown in the Schedule, but only with respect to liability for "bodily injury", "property damage" or "personal and advertising injury" caused, in whole or in part, by your acts or omissions or the acts or omissions of those acting on your behalf:
  - In the performance of your ongoing operations; or
  - **2.** In connection with your premises owned by or rented to you.

### However:

- The insurance afforded to such additional insured only applies to the extent permitted by law; and
- If coverage provided to the additional insured is required by a contract or agreement, the insurance afforded to such additional insured will not be broader than that which you are required by the contract or agreement to provide for such additional insured.

**B.** With respect to the insurance afforded to these additional insureds, the following is added to **Section III – Limits Of Insurance:** 

If coverage provided to the additional insured is required by a contract or agreement, the most we will pay on behalf of the additional insured is the amount of insurance:

- 1. Required by the contract or agreement; or
- 2. Available under the applicable Limits of Insurance shown in the Declarations;

whichever is less.

This endorsement shall not increase the applicable Limits of Insurance shown in the Declarations.

# PRIMARY AND NONCONTRIBUTORY – OTHER INSURANCE CONDITION

This endorsement modifies insurance provided under the following:

COMMERCIAL GENERAL LIABILITY COVERAGE PART PRODUCTS/COMPLETED OPERATIONS LIABILITY COVERAGE PART

The following is added to the **Other Insurance** Condition and supersedes any provision to the contrary:

## **Primary And Noncontributory Insurance**

This insurance is primary to and will not seek contribution from any other insurance available to an additional insured under your policy provided that:

- (1) The additional insured is a Named Insured under such other insurance; and
- (2) You have agreed in writing in a contract or agreement that this insurance would be primary and would not seek contribution from any other insurance available to the additional insured.

# **BUSINESS AUTO ENHANCEMENT – PLATINUM PLUS**

This endorsement modifies insurance provided under the following:

### **BUSINESS AUTO COVERAGE FORM**

### **SUMMARY OF COVERAGE EXTENSIONS**

Paragraph No.	Name Of Extension	Limit or Included
A.	Additional Insured by Contract Or Agreement Including Primary and Noncontributory Other Insurance Condition	Included
B.	Airbags - Extended Coverage	Included
C.	Telematics & GPS Equipment Coverage	\$2,500
D.	Electronic Equipment – Increased Coverage	\$2,500
E.	Auto Loan/Lease Gap Coverage	Unlimited
F.	Autos Rented by Employees	Included
G.	Bail Bonds - Extended Coverage	\$5,000
H.	Broad Form Named Insured Including Newly Acquired or Formed Organizations	Included
I.	Custom Signs & Decorations	Included
J.	Employees as Insureds	Included
K.	Family Emergency Travel Reimbursement	\$2,500
L.	Fellow Employee Coverage	Included
М	Fire Extinguisher Recharge	Included
N.	Glass Repair – No Deductible	Included
О.	Hired Auto Physical Damage and Increased Loss of Use Expenses \$100 Loss of use (Per Day / Maximum) \$500 /	
Р	Hybrid Auto Payment Coverage (per auto / per loss) \$2,	
Q.	Knowledge Of An Accident, Claim, Suit Or Loss	
R.	Limited Worldwide Hired & Non Owned Auto Coverage In	
S.	Loss Of Earnings - Extended Coverage \$1,00	
T.	New Vehicle Replacement Cost Inclu	
U.	Rental Reimbursement Coverage	
	Maximum Rental Expenses Per Day	\$75
	Maximum Rental Expenses Because Of Loss To Any One Covered "Auto"	\$3,375
	Maximum Rental Expenses Because Of Loss To All Covered "Autos" In Any One Policy Period	\$15,000

V.	Personal Effects Coverage	\$500
W.	Resultant Mental Anguish	
X.	Towing And Labor Coverage Extension Private Passenger Type Other than Private Passenger Type	\$200 \$250
Y.	Transportation Expenses - Coverage Extension ( Per Day / Maximum)	\$75 / \$2,500
Z.	Unintentional Failure To Disclose Hazards	Included
AA.	Waiver Of Collision Deductible – Attached Autos	Included
BB.	Waiver Of Subrogation By Contract Or Agreement	Included

# A. ADDITIONAL INSURED BY CONTRACT OR AGREEMENT INCLUDING PRIMARY AND NONCONTRIBUTORY OTHER INSURANCE CONDITION

The following is added to Paragraph A.1. Who Is An Insured of Section II – Covered Autos Liability Coverage:

When you have agreed in a written contract or agreement to include a person or organization as an additional insured, such person or organization is included as an "insured" subject to the following:

- Such person or organization is an additional insured only to the extent such person or organization is liable for "bodily injury" or "property damage" because of the conduct of an "insured" under Paragraphs a. or b. under Paragraph A.1. Who Is An Insured of Section II Covered Autos Liability Coverage, caused by an "accident" and resulting from the ownership, maintenance or use of a covered "auto".
- The written contract or agreement described above must have been executed prior to the "accident" that caused the "bodily injury" or "property damage" and be in effect at the time of such "accident".
- The insurance afforded to any such additional insured does not apply to any "accident" beyond the period of time required by the written contract or agreement described above.
- **4.** The most we will pay on behalf of such additional insured(s) is the lesser of:
  - The Limits of Insurance specified in the written contract or agreement described above; or
  - **b.** The Limits of Insurance shown in the Declarations.

This provision shall not increase the Limit of Insurance shown in the Declarations in this policy or coverage part.

- The following changes are made to Paragraph 5. Other Insurance of B. General Conditions under Section IV – Business Auto Conditions:
  - a. The following is added to Paragraph 5.a.:

    If required by the written contract or agreement described above, the insurance afforded to the additional insured under this provision will be primary to, and will not seek contribution from, the additional insured's own insurance.
  - **b.** Paragraph **5.c.** is deleted in its entirety.
- **6.** Paragraph **A.1.c.** under Section **II** Covered Autos Liability Coverage is deleted in its entirety.
- The definition of "insured contract" under Section V – Definitions is amended to add the following:

An "insured contract" does not include that part of any contract or agreement: That pertains to the ownership, maintenance or use of an "auto" and which indemnifies a person or organization for other than the vicarious liability of such person or organization for "bodily injury" or "property damage" caused by your operation or use of a covered "auto".

However, a person or organization is an additional "insured" under this provision only to the extent such person or organization is not named as an "insured" by separate endorsement to this policy.

## **B. AIRBAGS-EXTENDED COVERAGE**

Section III – Physical Damage Coverage, Paragraph B.3.a. does not apply to the unintended discharge of an airbag. Coverage is excess over any other collectible insurance or warranty specifically designed to provide coverage.

# C. TELEMATICS & GPS EQUIPMENT COVERAGE

**Physical Damage Coverage** is amended as follows:

- In Section III Physical Damage Coverage, Paragraphs B.4.c. and B.4.d. do not apply to:
  - a. Global positioning systems; or
  - **b.** "Telematics devices";

which are not:

- (1) Permanently installed in or upon the covered "auto";
- **(2)** Removable from a housing unit which is permanently installed in or upon the covered "auto":
- (3) An integral part of the same unit housing any electronic equipment described in Paragraphs **a.** and **b.** above; or;
- **(4)** Necessary for the normal operation of the covered "auto" or the monitoring of the covered "auto's" operating system.
- 2. In the event of a "loss" to a covered "auto", the most we will pay for "loss" to global positioning systems and "telematics devices" in any one covered "auto" is the lesser of:
  - **a.** The actual cash value of the damaged or stolen property at the time of loss;
  - **b.** The cost of repairing or replacing damaged or stolen property with other property of like kind and quality; or
  - **c.** \$2,500
- **3.** For each covered "loss", a deductible of \$100 shall apply.

"Telematics Devices" include devices that are not installed by the vehicle manufacturer and that are designed for the collection and dissemination of data for the purpose of monitoring vehicle and/or driver performance. This includes global positioning systems and wireless safety communication devices.

Cellular, mobile and smart phones are not considered global positioning systems or "telematics devices" for purposes of this coverage provision.

# D. ELECTRONIC EQUIPMENT - INCREASED COVERAGE

The \$1,000 limit indicated in Paragraph **C.1.b.** under Section **III** – Physical Damage Coverage is increased to \$2,500.

### E. AUTO LOAN/LEASE GAP COVERAGE

The following is added to **Section III – Physical Damage Coverage**, Paragraph **C**.:

In the event of a total "loss" to a covered "auto", we will pay any unpaid amount due on the lease or loan for a covered "auto", less:

The amount paid under the Physical Damage Coverage section of the policy; and any:

- Overdue lease/loan payments at the time of the "loss":
- Financial penalties imposed under a lease for excessive use, abnormal wear and tear or high mileage;
- **3.** Security deposits not returned by the lessor;
- Costs for extended warranties, Credit Life Insurance, Health, Accident or Disability Insurance purchased with the loan or lease; and
- Carry-over balances from previous loans or leases.

However, this provision does not apply to the extent loan/lease gap coverage has been provided by separate endorsement to this policy.

### F. AUTOS RENTED BY EMPLOYEES

The following is added to **Section II – Covered Autos Liability Coverage**, Paragraph **A.1.**:

The following is added to the **Who Is An Insured** Provision:

An "employee" of yours is an "insured" while operating an "auto" hired or rented under a contract or agreement in an "employee's" name, with your permission, while performing duties related to the conduct of your business

### G. BAIL BONDS - EXTENDED COVERAGE

**Section II – Covered Autos Liability Coverage**, Paragraph **A.2.a.(2)** is deleted and replaced by the following:

(2) Up to \$5,000 for cost of bail bonds (including bonds for related traffic law violations) required because of an "accident" we cover. We do not have to furnish these bonds.

# H. BROAD FORM NAMED INSURED INCLUDING NEWLY ACQUIRED OR FORMED ORGANIZATIONS

The following is added to sub paragraph A1. Who Is An Insured of Section II – Covered Autos Liability Coverage:

For any covered "auto";

Any organization, other than a partnership, joint venture or limited liability company, over which you maintain ownership or majority interest of more than 50 percent on the effective date of this endorsement and for which you are obligated prior to the loss to provide insurance, unless that organization is an "insured" under any other automobile policy or would be an "insured" under such a policy but for the exhaustion of its Limit of Insurance.

Any organization you newly acquire or form, other than a partnership, joint venture or limited liability company or any organization excluded either by this Coverage Part or by endorsement, and over which you maintain ownership or majority interest of more than 50 percent will qualify as a Named Insured. However:

- 1. This insurance does not apply to any newly acquired or formed organization that is an "insured" under any other automobile policy or would be an "insured" under such policy but for its termination or the exhaustion of its Limit of Insurance.
- Coverage under this provision does not apply to "bodily injury", "property damage", expense or "loss" that occurred before you acquired or formed the organization.
- Coverage under this provision is afforded only until the 180th day after you acquire or form the organization or the end of the policy period, whichever is earlier.

### I. CUSTOM SIGNS & DECORATIONS

Physical Damage coverage on a covered "auto" extends to "loss" to custom signs and decorations including custom murals, paintings or other decals or graphics.

Our limit of liability for each "loss" to custom signs and decorations shall be the least of:

- Actual cash value of the stolen or damaged property; or
- (2) Amount necessary to repair or replace the property;

This coverage does not apply to Hired Auto Physical Damage Coverage.

### J. EMPLOYEES AS INSUREDS

Section II- Covered Autos Liability Coverage, Paragraph A.1.b.(2) is deleted and replaced by the following:

(2) Any "employee" of yours is an "insured" while using a covered "auto" you don't own, hire or borrow in your business or your personal affairs.

However, the insurance provided by this provision, I. EMPOYEES AS INSUREDS, does not apply if separate Employee as Insured coverage (or any similar or equivalent coverage) has been provided by a separate endorsement issued by us and made a part of this policy or coverage part.

# K. FAMILY EMERGENCY TRAVEL REIMBURSEMENT

**SECTION II - LIABILITY COVERAGE, A. 2. Coverage Extensions** is amended to include the following:

In addition to the Limit of Insurance, we will pay reasonable "travel reimbursement expenses" incurred by a "family member" or "designated representatives", of an "insured" or passenger for travel to visit that "insured" or passenger who was injured in an "accident" involving a covered "auto", subject to the following conditions:

- 1. Regardless of the number of traveling members" "designated "family or representatives", injured "insureds" passengers, claims made or vehicles involved in the "accident", the most we will "travel reimbursement pay for all expenses" resulting from anv "accident" is \$ 2,500.
- 2. Travel must be to visit the injured party at the hospital to which such "insured" has been admitted and has received medical or surgical treatment for a period of 72 hours or more from the time of first admittance to such hospital, or in the event of death, to the location necessary to handle the immediate affairs of the deceased.
- 3. Subject to the \$2,500 per accident limit, the most we will pay for the combined total of expenses for room accommodations, meals, and parking for each "family member" or "designated representatives" is \$200 per day.
- **4.** We will reimburse ground transportation using a personal vehicle at a rate of 40 cents

per mile for the actual miles driven.

 All "travel reimbursement expenses" must be supported by written receipts submitted to us no later than 120 days from the date such "travel reimbursement expenses" were incurred.

"Travel reimbursement expenses" include reasonable ground, rail, or air (coach class) transportation, room accommodations, meals, and parking expenses only.

"Designated representative" is an individual identified by the "insured" as a close personal friend or as having decision making authority pertaining to the insured's care in the event of incapacity or death.

"Family member" means a person related to the injured "insured" by blood, marriage, state-recognized civil union, or adoption, including a ward or foster child.

#### L. FELLOW EMPLOYEE COVERAGE

Exclusion B. 5. of Section II - Covered Autos Liability Coverage is deleted and replaced with the following:

### 5. Fellow Employee

- a. "Bodily injury" to any fellow "employee" of an "insured" arising out of and in the course of the fellow "employee's" employment or while performing duties related to the conduct of your business; or
- **b.** The spouse, child, parent, brother or sister of that fellow "employee" as a consequence of Paragraph a. above.

However, this exclusion does not apply to liability incurred by your "employees" that are "executive officers".

No "employee" is an "insured" for "bodily injury" to a co-employee if such co-employee's exclusive remedy is provided under a workers compensation law or any similar law.

For the purpose of Fellow Employee Coverage only, paragraph **B.5.** of **Business Auto Conditions** is changed as follows:

This **FELLOW EMPLOYEE COVERAGE** is excess over any other collectible insurance.

As used in this provision, "executive officer" means a person holding any of the officer positions created by your charter, constitution, by-laws or any other similar governing document.

### M. FIRE EXTINGUISHER RECHARGE

The following is added to Paragraph A.4. Coverage Extensions of Section III – Physical Damage Coverage:

When fire extinguishers are kept in your covered "auto" and are discharged in an attempt to extinguish a fire, we will pay the lesser of the actual cost of recharging or replacing such fire extinguisher(s).

No deductible applies to this coverage.

### N. GLASS REPAIR - NO DEDUCTIBLE

**Section III – Physical Damage Coverage**, Paragraph **D**. is deleted and replaced by the following:

### D. DEDUCTIBLE

For each covered "auto" our obligation to pay for, repair, return or replace damaged or stolen property will be reduced by the applicable deductible shown in the Declarations. Any Comprehensive Coverage deductible shown in the Declarations does not apply to:

- 1. "Loss" caused by fire or lightning; or
- 2. "Loss" when you elect to patch or repair glass rather than replace.

# O. HIRED AUTO PHYSICAL DAMAGE COVERAGE AND INCREASED LOSS OF USE EXPENSES

Section III – Physical Damage Coverage, A. 4 Coverage Extensions is amended to include the following:

If hired "autos" are covered "autos" for Liability Coverage under this policy and if Physical Damage Comprehensive Coverage, Physical Damage Specified Causes Of Loss Coverage, or Physical Damage Collision Coverage is provided under this policy for any "auto" you own, then such Physical Damage Coverages are extended to apply to "autos" you lease, hire, rent or borrow without a driver, subject to the following provisions:

- This extension is only available for "autos" you lease, hire, rent or borrow for less than 30 consecutive days.
- 2. The most we will pay in any one "loss" is the least of \$100,000, the actual cash value of the "auto" or the cost to repair or replace the "auto", except that such amount will be reduced by a deductible to be determined as follows:
  - a. The deductible shall be equal to the

amount of the highest deductible shown for any owned "auto" of the same classification for that coverage. In the event there is no owned "auto" of the same classification, the highest deductible for any owned "auto" will apply for that coverage.

- **b.** No deductible will apply to "loss" caused by fire or lightning.
- 3. Coverage provided under this extension will be excess over any other collectible insurance you have.

Paragraphs 1 through 3 above do not apply if separate Hired Auto Physical Damage is indicated in the declarations.

4. For "autos" you lease, hire, rent or borrow covered under this Hired Auto Physical Damage Coverage extension or under separate coverage provided in the declarations, the limits in subparagraph b. Loss Of Use Expenses under paragraph 4. Coverage Extensions as found in paragraph A. Coverage of SECTION III – PHYSICAL DAMAGE COVERAGE, are increased to \$500 per day, to a maximum of \$3,500.

### P. HYBRID AUTO PAYMENT COVERAGE

Section III – Physical Damage Coverage, A. 4 Coverage Extensions is amended to include the following:

- In the event of a total "loss" to a non-"hybrid auto" for which Comprehensive, Specified Causes of Loss, or Collision coverages are provided under the Business Auto Coverage form, then Physical Damage Coverages are amended as follows:
  - a. If a non-"hybrid auto" is replaced with a "hybrid auto" or "electric auto" we will pay an additional 10% of the non-"hybrid auto's" actual cash value or replacement cost, to a maximum of \$2,500, whichever is less;
  - b. The non-"hybrid autos" must be replaced and a copy of a bill of sale or lease agreement must be received by us within 60 calendar days of the date of "loss"; and
  - **c.** If more than one non-"hybrid auto" is damaged in any one "loss", the most we will pay under this Coverage for any one "loss" is \$5,000.

- **2.** For the purpose of this coverage provision the following Definitions are added:
  - a. "Hybrid auto" is defined as an "auto", including a hybrid "electric auto" that is powered by two sources, an internal combustion engine, and an electric motor.
  - **b.** "Electric auto" is an "auto" that is powered by an electric motor instead of an internal combustion engine. The "electric auto" uses energy stored in its rechargeable batteries, which are recharged by common household electricity.

# Q. KNOWLEDGE OF AN ACCIDENT, CLAIM, SUIT OR LOSS

The following is added to **Section IV – Business Auto Conditions**, Paragraph **A.2.**:

Notice of an "accident" or "loss" will be considered knowledge of yours only if reported to you, if you are an individual, a partner, an executive officer or an employee designated by you to give us such notice.

Notice of an "accident" or "loss" to your Workers' Compensation insurer, for an event which later develops into a claim for which there is coverage under this policy, shall be considered notice to us, but only if we are notified as soon as you know that the claim should be addressed by this policy, rather than your Workers' Compensation policy.

# R. LIMITED WORLDWIDE HIRED & NON OWNED AUTO COVERAGE

- In **Section IV Business Auto Conditions,** Condition **B.7.**, paragraph b.(5) is replaced by the following:
- (5) Anywhere in the world if a covered "auto" is leased, hired, rented or borrowed without a driver for a period of 30 days or less,

# S. LOSS OF EARNINGS - EXTENDED COVERAGE

- Section II Covered Autos Liability Coverage, Paragraph A.2.a.(4) is deleted and replaced by the following:
- (4) All reasonable expenses incurred by the "insured" at our request, including actual loss of earnings up to \$1,000 a day because of time off from work.

### T. NEW VEHICLE REPLACEMENT COST

The following is added to the Paragraph C. Limit of Insurance provision of Section III – Physical Damage Coverage:

In the event of a total "loss" to your "new vehicle" to which this coverage applies, we will pay at your option:

- **a.** The cost to replace the covered "auto" with a new "auto" of like make, model and year; or
- **b.** An amount equal to the original purchase price you paid to acquire the vehicle, including taxes, but excluding any extended warranties and licensing fees.

This coverage applies only to a covered "auto" of the private passenger, light truck or medium truck type (20,000 lbs. or less gross vehicle weight).

As used in this endorsement, a "new vehicle" means an "auto" of which you are the original owner that has not been previously titled and which you purchased less than 180 days before the date of the "loss".

### U. RENTAL REIMBURSEMENT COVERAGE

- 1. We will pay for rental reimbursement expenses incurred by you for the rental of an "auto" because of "loss" to a covered "auto". Payment applies in addition to the otherwise applicable amount of each coverage you have on a covered "auto". No deductible applies to this coverage. This coverage is only available to those covered "autos" involved in a "loss" and Physical Damage is provided to the covered "auto".
- 2. We will pay only for those expenses incurred during the policy period, beginning 24 hours after the "loss" and ending, regardless of the expiration date of the policy, with the lesser of the following;
  - The number of days reasonably required to repair or replace the covered "auto". If "loss" is caused by theft, this number of days is added to the number of days it takes to locate the covered "auto" and return it to you; or
  - **2.** 45 days.
- **3.** Our payment is limited to the lesser of the following amounts:
  - 1. Necessary and actual expenses incurred.
  - **2.** The maximum rental expenses indicated below:
    - (1) Not more than \$75 per day;

- (2) The maximum rental expenses shown below:
  - (a) \$3,375 because of "loss" to any one covered "auto";
  - (b) \$15,000 because of all "loss" to all covered "autos" in any one policy period.
- 4. We will pay up to an additional \$300 for the reasonable and necessary expenses you incur to remove your materials and equipment from the covered "auto" and replace such materials and equipment on the rental "auto".
- **5.** This coverage does not apply while there are spare or reserve "autos" available to you for your operations.
- 6. If "loss" results from the total theft of a covered "auto" of the private passenger type, we will pay under this coverage only that amount of your rental reimbursement expenses which is not already provided for under the Physical Damage Coverage Extension.

### V. PERSONAL EFFECTS COVERAGE

The following is added to **Section III – Physical Damage Coverage**, Paragraph **A.4**.:

Physical Damage Coverage on a covered "auto" is extended to "loss" to your personal property and, if you are an individual, the personal property of a family member, that is in the covered "auto" at the time of "loss"; and caused by an "accident" and resulting from the ownership, maintenance or use of a covered "auto"

The most we will pay for any one "loss" under this coverage extension is \$500. However, our payment for "loss" to personal property will only be for the account of the owner of the property.

Under this provision personal property does not include and we will not pay for "loss" of:

- 1. Currency, coins, securities or
- 2. Property that under federal or state law is
  - a. An illegal controlled substance
  - **b.** Property in the course of illegal transportation or trade.

No deductible applies to this coverage extension.

### W. RESULTANT MENTAL ANGUISH

**Section V - Definitions**, Paragraph **C.** is deleted and replaced by the following:

C. "Bodily injury" means bodily injury, disability, sickness, or disease sustained by a person, including death resulting from any of these at any time. "Bodily injury" includes mental anguish or other mental injury resulting from "bodily injury".

# X. TOWING AND LABOR COVERAGE EXTENSION

The following is added to **Section III – Physical Damage Coverage**, paragraph **A.2.**:

- 1. We will pay up to:
  - a. \$200 for a covered "auto" of the private passenger type or
  - **b**. \$250 for a covered "auto" that is not of the private passenger type.

for towing and labor costs incurred each time the covered "auto" is disabled. However, the labor must be performed at the place of disablement.

- This coverage applies only for an "auto" covered on this policy for Comprehensive or Specified Causes of Loss Coverage and Collision Coverages.
- 3. Payment applies in addition to the otherwise applicable amount of each coverage you have on a covered "auto".

# Y. TRANSPORTATION EXPENSES - COVERAGE EXTENSION

Paragraph A.4.a. Transportation Expenses of Section III – Physical Damage Coverage is amended as follows:

- 7. The Limits of Insurance are increased to \$75 per day to a maximum of \$2,500.
- 8. We will also pay reasonable and necessary expenses to facilitate the return of the stolen "auto" to you.

# Z. UNINTENTIONAL FAILURE TO DISCLOSE HAZARDS

The following is added to **Section IV - Business Auto Conditions**, Paragraph **B.2**.:

If you unintentionally fail to disclose any hazards existing at the inception of this policy, such failure will not prejudice the coverage provided to you. However, this provision does not affect our right to collect additional premium or exercise our right of cancellation or nonrenewal.

# AA. WAIVER OF COLLISION DEDUCTIBLE – ATTACHED AUTOS

The following is added to paragraph **D.** under **SECTION III - PHYSICAL DAMAGE COVERAGE** of the Business Auto Coverage Form:

If a "trailer" is connected to an "auto" that is not a "trailer" and both "autos":

- Are covered "autos" for Collision Coverage that applies to that "accident", and
- 2. Sustain damage in a single "accident".

we will waive the lowest of the applicable Collision deductibles.

# BB. WAIVER OF SUBROGATION BY CONTRACT OR AGREEMENT

The following is added to **Section IV** - **Business Auto Conditions**, Paragraph **A.5.**:

We waive any right of recovery we may have against any "insured" provided coverage under this endorsement under A. ADDITIONAL INSURED BY CONTRACT OR AGREEMENT INCLUDING PRIMARY AND NONCONTRIBUTORY OTHER INSURANCE CONDITION, but only as respects "loss" arising out of the operation, maintenance or use of a covered "auto" pursuant to the provisions or conditions of the written contract or agreement.

(Ed. 4-84)

## WAIVER OF OUR RIGHT TO RECOVER FROM OTHERS ENDORSEMENT

We have the right to recover our payments from anyone liable for an injury covered by this policy. We will not enforce our right against the person or organization named in the Schedule. (This agreement applies only to the extent that you perform work under a written contract that requires you to obtain this agreement from us.)

This agreement shall not operate directly or indirectly to benefit anyone not named in the Schedule.

	Schedule
Specific Waiver     Name of person or organization	
Blanket Waiver     Any person or organization for v	vhom the Named Insured has agreed by written contract to furnish this waiver
2. Operations:	
3. Premium: <b>\$ 0</b>	The premium charge for this endorsement shall be included in the premium developed on payroll in conjunction with work performed for the above person(s) or organization(s) arising out of the operations described.
4. Minimum Premium: \$ 250	
Maximum Premium: \$ 0	
This endorsement changes the police	by to which it is attached and is effective on the date issued unless otherwise stated.
(The information below is required	only when this endorsement is issued subsequent to preparation of the policy.)
Endorsement Effective 06/29/2019 Insured T3 Wireless, Inc.	Policy No. AVWCIA2807792019 Endorsement No. Premium
Insurance Company	Countersigned by

WC 00 03 13

(Ed. 4-84)

AMERICAN INTERSTATE INSURANCE COMPANY - 24759

# TELECOMMUNICATIONS LIABILITY ENHANCEMENT ENDORSEMENT

This endorsement modifies insurance under the following:

COMMERCIAL GENERAL LIABILITY COVERAGE PART

### A. Medical Payments

If Coverage C Medical Payments is not otherwise excluded from this Coverage Part, the Medical Expense Limit provided by this policy, subject to the terms of Section III - Limits Of Insurance, shall be the greater of:

- **1.** \$10,000; or
- **2.** The Medical Expense Limit shown in the Declarations of this Coverage Part.
- B. Legal Liability Damage To Premises Rented To You (Fire, Lightning, Explosion, Smoke And Leakage From Automatic Fire Protective Systems)

If damage by fire to premises rented to you is not otherwise excluded from this policy or coverage part, then the following provisions apply:

- The last paragraph of Section I Coverages A.2. Exclusions is deleted and replaced by the following:
   Exclusions c. through n. do not apply to damage by fire, lightning, explosion, or leakage from automatic fire protective systems to premises while rented to you or temporarily occupied by you with the permission of the owner. A separate limit of insurance applies to this coverage as described in Section III Limits Of Insurance.
- 2. The paragraph immediately after Subparagraph j.(6) of Paragraph 2. Exclusions of Section I Coverage A Bodily Injury And Property Damage Liability is deleted and replaced by the following: Paragraphs (1), (3) and (4) of this exclusion do not apply to "property damage" (other

than damage by fire, lightning, explosion,

and leakage from automatic fire protective

systems) to premises, including the contents of such premises, rented to you for a period of 7 or fewer consecutive days. A separate limit of insurance applies to Damage To Premises Rented To You as described in **Section III – Limits Of Insurance**.

- **3.** Paragraph **6.** of **Section III Limits Of Insurance** is deleted and replaced by the following:
  - **6.** Subject to Paragraph **5.** above, the greater of:
    - **a.** \$300,000; or
    - **b.** The Damage To Premises Rented To You Limit shown in the Declarations;

is the most we will pay under **Coverage A** for damages because of "property damage" to premises while rented to you, or in the case of damage by fire, lightning, explosion, or leakage from automatic fire protective systems, while rented to you or temporarily occupied by you with permission of the owner.

This limit will apply to all damage proximately caused by the same event, whether such damage results from fire, lightning, explosion, leakage from automatic fire protective systems, or other covered causes of loss or any combination thereof.

- Subparagraph b.(1)(a)(ii) of Paragraph 4.
   Other Insurance of Section IV –
   Commercial General Liability Conditions is deleted and replaced by the following:
  - (b) That is fire, lightning, explosion, leakage from automatic fire protective systems insurance for premises rented to you or

temporarily occupied by you with permission of the owner;

- Subparagraph a. of definition 9. "insured contract" of Section V Definitions is deleted and replaced by the following:
  - a. A contract for a lease of premises. However, that portion of the contract for a lease of premises that indemnifies any person or organization for damage by fire, lightning, explosion, leakage from automatic fire protective systems to premises while rented to you or temporarily occupied by you with permission of the owner is not an "insured contract".

## C. Fellow Employee Coverage

Paragraph 2.a.(1) of Section II – Who Is An Insured is deleted and replaced by the following:

- (1) "Personal and advertising injury":
  - (a) To you, to your partners or members (if you are a partnership or joint venture), to your members (if you are a limited liability company), or to a co-"employee" while in the course of his or her employment or performing duties related to the conduct of your business;
  - (b) To the spouse, child, parent, brother or sister of that co-"employee" as a consequence of Paragraph (1)(a) above;
  - (c) For which there is any obligation to share damages with or repay someone else who must pay damages because of the injury described in Paragraphs (1)(a) or (b) above; or
  - (d) Arising out of his or her providing or failing to provide professional health care services.

### D. Additional Insured - Automatic Status

 Section II – Who Is An Insured is amended to include as an additional insured any person or organization for whom you are performing operations when you and such person or organization have agreed in writing in a contract or agreement that such person or organization be added as an additional insured on your policy. Such person or organization is an additional insured only with respect to liability for "bodily injury", "property damage" or "personal and advertising injury" caused, in whole or in part, by:

- a. Your acts or omissions; or
- **b.** The acts or omissions of those acting on your behalf;

in the performance of your ongoing operations for the additional insured.

### However:

The insurance afforded to such additional insured only applies to the extent permitted by law; and

If coverage provided to the additional insured is required by a contract or agreement, the insurance afforded to such additional insured will not be broader than that which you are required by the contract or agreement to provide for such additional insured.

A person or organization's status as an additional insured under this endorsement ends when your operations for that additional insured are completed.

- 2. With respect to the insurance afforded to these additional insureds, the following additional exclusions apply:
  This insurance does not apply to:
  - a. "Bodily injury", "property damage" or "personal and advertising injury" arising out of the rendering of, or the failure to render, any professional architectural, engineering or surveying services, including:
    - (1) The preparing, approving, or failing to prepare or approve, maps, shop drawings, opinions, reports, surveys, field orders, change orders or drawings and specifications; or
    - (2) Supervisory, inspection, architectural or engineering activities.
  - **b.** "Bodily injury" or "property damage" occurring after:
    - (1) All work, including materials, parts or equipment furnished in

connection with such work, on the project (other than service, maintenance or repairs) to be performed by or on behalf of the additional insured(s) at the location of the covered operations has been completed; or

- (2) That portion of "your work" out of which the injury or damage arises has been put to its intended use by any person or organization other than another contractor or subcontractor engaged in performing operations for a principal as a part of the same project.
- 3. Paragraph 4.b. of Section IV Commercial General Liability Conditions is deleted and replaced with the following:

#### b. Excess Insurance

- (1) This insurance is excess over:
  - (a) Any of the other insurance, whether primary, excess, contingent or on any other basis that is available to the additional insured unless you and the insured additional specifically agreed in writing that this insurance be primary. Then we will treat any other insurance maintained by the additional insured for injury or damage covered by provision Miscellaneous **Additional** Insureds, except such other insurance as noted Paragraph b.(1)(b) below, as excess to this insurance.

If specifically required by such written contract or written agreement, we will not seek contribution from any other liability insurance available to the additional insured for injury or damage covered by provision A. Miscellaneous Additional Insureds, except for such other insurance as noted in Paragraph b.(1)(b) below.

(b) Any other primary liability insurance available to the additional insured for damages arising out of premises or ongoing operations for which such person or organization has been added as an additional insured by attachment of an endorsement.

- (2) When this insurance is excess, we will have no duty under Section I Coverage A Bodily Injury And Property Damage Liability or Coverage B Personal And Advertising Injury Liability to defend the insured against any "suit" if any other insurer has a duty to defend the insured against that "suit". If no other insurer defends, we will undertake to do so, but we will be entitled to the insured's rights against all those other insurers.
- (3) When this insurance is excess over other insurance, we will pay only our share of the amount of the loss, if any, that exceeds the sum of:
  - (a) The total amount that all such other insurance would pay for the loss in the absence of this insurance; and
  - **(b)** The total of all deductible and self-insured amounts under all that other insurance.
- (4) We will share the remaining loss, if any, with any other insurance that is not described in this Excess Insurance provision and was not bought specifically to apply in excess of the Limits of Insurance shown in the Declarations of this policy or coverage part.

#### E. Broadened Named Insured

Paragraph 3. of Section II - Who Is An Insured is deleted and replaced by the following: Any organization, other than a joint venture, over which you maintain ownership or majority interest of more than 50%, will be a Named Insured if there is no other similar insurance available to that organization. However:

a. Coverage under this provision is afforded only until the 180th day after you acquire or form the organization or the end of the policy period, whichever is earlier.

- b. COVERAGE A does not apply to "bodily injury" or "property damage" that occurred before you acquired or formed the organization.
- c. COVERAGE B does not apply to "personal and advertising injury" arising out of an offense committed before you acquired or formed the organization.

# F. Aggregate Limits Of Insurance

The General Aggregate Limit under **Section III – Limits Of Insurance** applies separately to each of your:

- **1.** Projects away from premises owned by or rented to you.
- 2. "Locations" owned by or rented to you.

"Location" means premises involving the same or connecting lots, or premises whose connection is interrupted only by a street, roadway, waterway or right-of-way of a railroad.

# G. Waiver Of Transfer Of Rights Of Recovery Against Others

Paragraph 8. Transfer Of Rights Of Recovery Against Others To Us of Section IV – Commercial General Liability Conditions is amended by the addition of the following:

We waive any right of recovery we may have because of payments we make for injury or damage arising out of your ongoing operations or "your work" done under a contract requiring such waiver with that person or organization and included in the "products-completed operations hazard".

However, our rights may only be waived prior to the "occurrence" giving rise to the injury or damage for which we make payment under this Coverage Part. The insured must do nothing after a loss to impair our rights. At our request, the insured will bring "suit" or transfer those rights to us and help us enforce those rights.

### H. Mental Anguish

Paragraph 3. of **Section V – Definitions** is deleted and replaced by the following:

"Bodily injury" means bodily injury, sickness or disease sustained by a person, including mental anguish or death resulting from any of these at any time.

### I. Garagekeepers Coverage

The following is added to Section I – Coverages:

### 1. Coverage

We will pay all sums you legally must pay as damages for loss to a "customer's auto" or "customer's auto" equipment left in your care while you are attending, servicing, repairing, parking or storing it in your telecommunication utility operations under:

## a. Comprehensive Coverage

From any cause except:

- (1) The "customer's auto's" collision with another object; or
- (2) The "customer's auto's" overturn.

# b. Collision Coverage

Caused by:

(1) The "customer's auto's" collision with another object; or the "customer's auto's" overturn.

### 2. Exclusions

**a.** This insurance does not apply to any of the following:

# (1) Contractual Obligations

Liability resulting from any agreement by which you accept responsibility for direct physical loss of or damage (including any resulting loss of use) to "autos" left in your care.

## (2) Theft

Loss or damage due to theft or conversion caused in any way by you or any other insured.

### (3) Defective Parts

Defective parts or materials.

### (4) Faulty Work

Defective work you performed, including work that someone performed for you.

- **b.** We will not pay for loss to any of the following:
  - (1) Tape decks or other sound reproducing equipment unless permanently installed in a "customer's auto".
  - (2) Tapes, records or other sound reproducing devices designed for use with sound reproducing equipment.

- (3) Sound receiving equipment designed for use as a citizens' band radio, two-way mobile radio or telephone or scanning monitor receiver, including its antennas and other accessories, unless permanently installed in the dash or console opening normally used by the "customer's auto" manufacturer for the installation of a radio.
- (4) Any device designed or used to detect speed measurement equipment such as radar or laser detectors and any jamming apparatus intended to elude or disrupt speed measurement equipment.

### 3. Limit Of Insurance And Deductible

- a. Regardless of the number of "customer's autos", insureds, premiums paid, claims made or "suits" brought, the most we will pay for each loss at each location is \$50,000 minus the applicable deductible.
- **b.** A \$500 deductible applies to all loss in any one event caused by all perils, including collision.
- c. Sometimes to settle a claim or "suit", we may pay all or any part of the deductible. If this happens you must reimburse us for the deductible or that portion of the deductible that we paid.

### 4. Additional Definitions

As used in this endorsement:

"Customer's auto" means a customer's land motor vehicle or trailer or semitrailer. This definition also includes any customer's auto while left with you for service, repair, storage or safekeeping. Customers include your employees, and members of their households who pay for services performed.

## J. Telephone Directory Liability Coverage

1. We will pay on behalf of you all sums which you shall become legally obligated to pay as damages because of a misprint, typographical error, or omission of a listing or advertising or part thereof in any telephone directory published by or for you.

### 2. Limit Of Liability

Regardless of the number of:

- a. Insureds under this policy;
- Telephone directory editions printed; and
- **c.** Claims made or suits brought on account of inquiry; our Limit of Liability for all loss as a result of all occurrences taking place during the policy period shall be, in the aggregate, no more than \$1,000,000.

### K. Railroad Easement Agreements

With respect to operations performed for, or affecting, a railroad at your job site, the definition of "insured contract" in the Definitions section is replaced by the following:


- 9. "Insured Contract" means:
  - a. A contract for a lease of premises. However, that portion of the contract for a lease of premises that indemnifies any person or organization for damage by fire to premises while rented to you or temporarily occupied by you with permission of the owner is not an "insured contract":
  - **b.** A sidetrack agreement;
  - **c.** Any easement or license agreement;
  - **d.** An obligation, as required by ordinance, to indemnify a municipality, except in connection with work for a municipality;
  - e. An elevator maintenance agreement;
  - f. That part of any other contract or agreement pertaining to your business (including an indemnification of a municipality in connection with work performed for a municipality) under which you assume the tort liability of another party to pay for "bodily injury" or "property damage" to a third person or organization. Tort liability means a liability that would be imposed by law in the absence of any contract or agreement.

Paragraph **f.** does not include that part of any contract or agreement:

- (1) That indemnifies an architect, engineer, or surveyor for injury or damage arising out of:
  - (a) Preparing, approving or failing to prepare or approve maps, shop drawings, opinions, reports, surveys, field orders, change orders or drawings and specifications; or
  - (b) Giving directions or instructions, or failing to give them, if that is the primary cause of the injury or damage;
- (2) Under which the insured, if an architect, engineer or surveyor, assumes liability for an injury or damage arising out of the insured's rendering or failure to render professional services, including those listed in Paragraph (1) above and supervisory, inspection, architectural or engineering activities.

### L. Other Insurance

If this policy includes a Coverage Form or an Endorsement which provides coverage for loss or damage covered by one or more of the Extensions of this endorsement, the limit and the coverage provided by this endorsement are deleted and replaced by the limit and coverage provided by that Coverage Form or Endorsement.

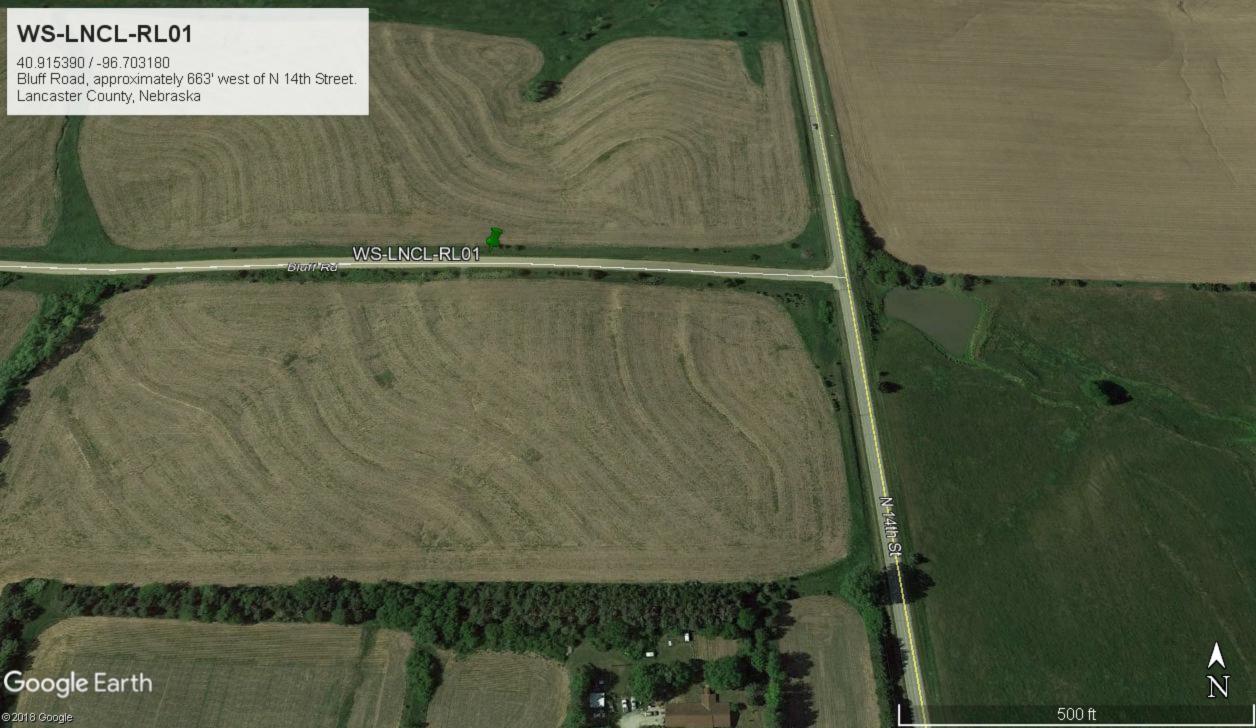

# WS-LNCL-RL01

1244 BLUFF ROAD LINCOLN, NE 68531

# SITE INFORMATION

 SITE ID:
 WS-LNCL-RL01

 ADDRESS:
 1244 BLUFF ROAD LINCOLN, NE 68531

 COUNTY:
 LANCASTER COUNTY

 LATITUDE:
 40.9153761\*

 LONGITUDE:
 -96.7034978\*

## **CONTACTS**

PROJECT MANAGER:

JURISDICTION:

WINDSTREAM

LANCASTER COUNTY


PROFESSIONAL ENGINEER: IRISH TOWER, LLC 4603 BERMUDA DRIVE

SUGAR LAND, TEXAS 77479 jacob.goralski@irishtower.com

PROPERTY OWNER:

### **GENERAL NOTES**

THE FACILITY IS NOT FOR HUMAN HABITATION. A TECHNICIAN WILL VISIT THE SITE AS REQUIRED FOR ROUTINE MAINTENANCE. THE PROJECT WILL NOT RESULT IN ANY SIGNIFICANT DISTURBANCE OR EFFECT ON DRAINAGE; NO SANITARY SEWER SERVICE, POTABLE WATER, OR TRASH DISPOSAL IS REQUIRED AND NO COMMERCIAL SIGNAGE IS NEW. THE SITE LOCATION IS SUBJECT TO MOVING, UP TO 10' FROM PROPOSED LOCATION, AS NEEDED TO KEEP WITHIN PUBLIC ROW, AVOID EXISTING UTILITY LINES, AND AVOID LINE-OF-SIGHT OBSTRUCTIONS WITH BOTH FOOT AND AUTOMOTIVE TRAFFIC: CONTRACTOR SHALL NOTIFY ENGINEER OF RECORD PRIOR TO ANY CHANGES.

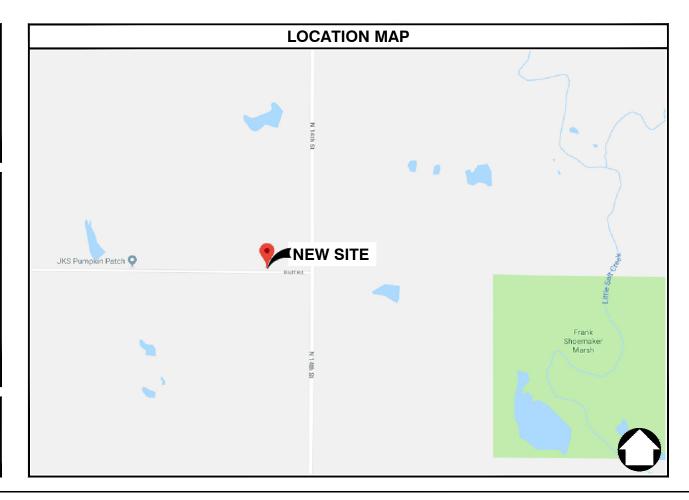

# PROJECT DESCRIPTION

THESE DRAWINGS DEPICT AN UTILITY POLE WITH ANTENNA INSTALLATION TO PROVIDE HIGH SPEED INTERNET SERVICE IN RURAL AREAS. THIS INSTALLATION SHALL CONSIST OF THE PLACEMENT OF A NEW POLE, FOUR (4) ANTENNAS, ONE (1) CONCEALMENT CABINET AND ASSOCIATED ELECTRICAL COMPONENTS AND MOUNTING BRACKETS AS REQUIRED

# **ENGINEERING**

2012 INTERNATIONAL FIRE CODE CITY AND/OR COUNTY ORDINANCES LOCAL BUILDING CODE(S) ANSI EIA/TIA 222-G

ALL WORK AND MATERIALS SHALL BE PERFORMED AND INSTALLED IN ACCORDANCE WITH THE CURRENT EDITIONS OF THE FOLLOWING CODES AS ADOPTED BY THE LOCAL GOVERNING AUTHORITIES. NOTHING IN THESE PLANS IS TO BE CONSTRUCTED TO REPORT WORK MOT CONFORMING TO THESE CODES.

2011 NATIONAL ELECTRICAL CODE
2012 INTERNATIONAL BUILDING CODE
2012 INTERNATIONAL MECHANICAL CODE
2012 INTERNATIONAL PLUMBING CODE
2012 LIFE SAFETY CODE (NFPA 101)

### DRAWING INDEX

SHEET NO: SHEET TITLE

T-1 TITLE SHEET

T-2 GENERAL NOTES

C-1 SITE PLANS

C-2 ELEVATION DETAILS

C-3 ANTENNA LAYOUT DETAILS

C-4 STRUCTURE DETAILS

NOTE: DRAWINGS ARE SCALED TO 11X17

ELECTRICAL & GROUNDING DETAILS

CONTRACTOR SHALL VERIFY ALL PLANS & EXISTING DIMENSIONS & CONDITIONS ON THE JOB SITE & SHALL IMMEDIATELY NOTIFY THE ARCHITECT OR ENGINEER IN WRITING OF ANY DISCREPANCIES BEFORE PROCEEDING WITH THE WORK OR BE RESPONSIBLE FOR SAME.









DRAWN BY:	JRR
DATE:	06/04/2019

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REV	DATE	DESCRIPTION	BY
0	06/04/2019	FINAL CD	JRR

IT IS A VIOLATION OF LAW FOR ANY PERSON UNLESS THEY ARE ACTING UNDER THE DIRECTION OF A LICENSED PROFESSIONAL ENGINEER, TO ALTER THIS DOCUMENT.

### WS-LNCL-RL01

1244 BLUFF ROAD LINCOLN, NE 68531 LANCASTER COUNTY

SHEET TITLE

TITLE SHEET

SHEET NUMBER

T-1

#### GENERAL NOTES

- 1. THE CONTRACTOR SHALL BE RESPONSIBLE FOR SURVEY MONUMENTS AND/OR VERTICAL CONTROL BENCHMARKS WHICH ARE DISTURBED OR DAMAGED BY CONSTRUCTION. A LAND SURVEYOR MUST FIELD LOCATE, REFERENCE, AND/OR PRESERVE ALL HISTORICAL OR CONTROLLING MONUMENTS PRIOR TO ANY EARTHWORK. IF DAMAGED, SUCH MONUMENTS SHALL BE REPLACED WITH APPROPRIATE MONUMENTS BY A LAND SURVEYOR. A CORNER RECORD OR RECORD OF SURVEY, AS APPROPRIATE, SHALL BE FILED AS REQUIRED BY THE PROFESSIONAL LAND SURVEYORS ACT.
- 2. IMPORTANT NOTICE: CONTRACTOR SHALL CALL LOCAL UNDERGROUND LOCATE SERVICE THREE WORKING DAYS BEFORE ANY CONSTRUCTION.
- 3. CONTRACTOR SHALL BE RESPONSIBLE FOR LOCATING ALL EXISTING UTILITIES WITHIN PROPOSED EXCAVATIONS AND MUST MAINTAIN MINIMUM VERTICAL AND HORIZONTAL CLEARANCES AS CALLED FOR BY LOCAL CODES AND/OR ORDINANCES.
- 4. CONTRACTOR IS RESPONSIBLE FOR REPAIR AND/OR REPLACEMENT OF ANY EXISTING STRUCTURES OR LANDSCAPING DAMAGED DURING CONSTRUCTION.
- 5. CONTRACTOR SHALL REPLACE OR REPAIR ALL TRAFFIC SIGNAL LOOPS, CONDUIT, AND LANE STRIPING DAMAGED DURING CONSTRUCTION.
- 6. THIS PROJECT WILL BE INSPECTED BY ENGINEERING AND FIELD ENGINEERING DIVISION.
- 7. ANY MANHOLES OR COVERS INSTALLED AS PART OF THIS PROJECT SHALL BE LABELED COMMUNICATIONS.
- 8. THE CONTRACTOR SHALL BE RESPONSIBLE FOR IMPLEMENTATION OF AN EROSION CONTROL PLAN WHICH MEETS ALL APPLICABLE REQUIREMENTS OF STATE AND LOCAL AGENCIES HAVING JURISDICTION.
- 9. THE CONTRACTOR SHALL MAINTAIN MATERIALS AND EQUIPMENT ON SITE FOR UNFORESEEN SITUATIONS INCLUDING DAMAGE TO UNDERGROUND WATER, SEWER, AND STORM DRAIN FACILITIES WHICH COULD GENERATE FLOWS ABLE TO CAUSE EROSION AND SEDIMENT POLITICION

#### SPECIAL NOTES

- 1. INDEMNIFICATION CLAUSE: THE CONTRACTOR AGREES AND SHALL: ASSUME SOLE AND COMPLETE RESPONSIBILITY OF THE JOB SITE CONDITIONS DURING THE COURSE OF CONSTRUCTION OF THIS PROJECT, INCLUDING THE SAFETY OF ALL PERSONS AND PROPERTIES. THESE REQUIREMENTS SHALL APPLY CONTINUOUSLY AND NOT BE LIMITED TO NORMAL WORKING HOURS AND CONDITIONS. THE CONTRACTOR FURTHER AGREES TO DEFEND INDEMNITY AND HOLD OWNER, REPRESENTATIVES, AND ENGINEERS HARMLESS FROM ANY AND ALL LIABILITY, REAL OR ALLEGED IN CONNECTION WITH THE PERFORMANCE OF THE WORK ON THIS PROJECT.
- 2. PRIOR TO START OF CONSTRUCTION AND THROUGH PROJECT COMPLETION, THE CONTRACTOR SHALL REMAIN IN FULL COMPLIANCE WITH CURRENT FEDERAL, STATE, AND LOCAL OCCUPATIONAL HEALTH AND SAFETY REGULATIONS.
- 3. ALL WORK SHALL CONFORM TO THE LATEST STANDARD "SPECIFICATIONS FOR PUBLIC WORKS CONSTRUCTION" AS ADOPTED BY THE CITY, COUNTY OR STATE AND AS MODIFIED BY STANDARD PLANS AND ADDENDLINS.
- 4. ALL UTILITIES AND OTHER FACILITIES DEPICTED ON THE PLANS ARE BASED ON A SEARCH OF AVAILABLE RECORDS AND FIELD OBSERVATIONS. THE CONTRACTOR SHALL VERIFY PRIOR TO CONSTRUCTION START AND USE EXTREME CARE AND PROTECTIVE MEASURES TO AVOID DAMAGE TO ANY FACILITIES WETHER OR NOT INDICATED ON THESE PLANS. THE CONTRACTOR IS RESPONSIBLE FOR THE PROTECTION OF ALL FACILITIES WITHIN THE LIMITS OF WORK, WHETHER OR NOT DEPICTED ONT THESE PLANS.
- 5. THE CONTRACTOR SHALL BE RESPONSIBLE FOR NOTIFICATION OF ANY CITY, COUNTY OR STATE ENGINEER INSPECTION DEPARTMENT A MINIMUM TWO DAYS PRIOR TO COMMENCEMENT OF ACTIVITY REQUIRING THEIR INVOLVEMENT.
- 6. THE EXPIRATION OF THE PERMIT FOR THIS PROJECT SHALL BE SPECIFIED BY THE LOCAL AUTHORITY HAVING JURISDICTION.
- 7. ALL UNDERGROUND CONDUITS PLACED AS PART OF THIS PROJECT MUST HAVE A MINIMUM COVER OF 48 INCHES UNLESS OTHERWISE APPROVED.
- 8. THE CONTRACTOR SHALL TUNNEL ALL CURB AND GUTTERS AND BORE ALL CONCRETE DRIVEWAYS AND WALKWAYS AT THE DIRECTION OF THE CITY, COUNTY OR STATE ENGINEER HAVING JURISDICTION.
- 9. ALL PAVEMENT CUT OR DAMAGED AS PART OF THIS PROJECT SHALL BE REPLACED AT THE DIRECTION OF THE CITY, COUNTY OR STATE ENGINEER HAVING JURISDICTION.
- 10. ALL SHRUBS, PLANTS OR TREES DAMAGED OR DISTURBED DURING THE COURSE OF THE WORK, SHALL BE REPLANTED AND/OR REPLACED SO AS TO RESTORE THE WORK SITE TO ITS ORIGINAL CONDITION.
- 11. THE CONTRACTOR SHALL BE RESPONSIBLE FOR PROCESSING OF ALL APPLICANT PERMIT FORMS ALONG WITH REQUIRED LIABILITY INSURANCE FORMS CLEARLY DEMONSTRATING OWNER, OWNER REPRESENTATIVES, ENGINEER, AND CITY, COUNTY OR STATE ARE ALSO INSURED WITH THE REQUIRED LIABILITY INSURANCE FOR THIS CONSTRUCTION PROJECT.
- 12. ALL SUBSURFACE STRUCTURES INCLUDING BUT NOT LIMITED TO VAULTS, PEDESTALS, AND CONDUITS SHALL BE AS SPECIFIED IN THESE PLANS OR AS SPECIFIED BY THE ENGINEER. ANY DEVIATIONS SHALL BE APPROVED BY THE ENGINEER IN WRITING PRIOR TO INSTALLATION.
- 13. THE CONTRACTOR IS RESPONSIBLE FOR VERIFICATION OF ALL EXISTING UTILITIES, INCLUDING BUT NOT LIMITED TO SEWER LATERALS AND WATER SERVICES, BOTH VERTICAL AND HORIZONTAL, PRIOR TO COMMENCING IMPROVEMENT OPERATIONS.
- 14. THE CONTRACTOR IS RESPONSIBLE FOR COMPLETION OF EXPLORATION EXCAVATIONS CONDUCTED FOR THE PURPOSE OF LOCATING EXISTING FACILITIES SUFFICIENTLY AHEAD OF CONSTRUCTION TO PERMIT REVISIONS TO PLANS AS REQUIRED.

  15. LOCATIONS OF EXISTING LITHIUTIES ON THESE PLANS ARE BASED LIPON EXISTING RECORD
- 15. LOCATIONS OF EXISTING UTILITIES ON THESE PLANS ARE BASED UPON EXISTING RECORDS VERIFIED WHERE POSSIBLE WITH FIELD TIES. CONTRACTOR IS RESPONSIBLE FOR VERIFICATION OF LOCATIONS SHOWN, BOTH HORIZONTAL AND VERTICALLY. PRIOR TO CONSTRUCTION, SUBSTANTIAL VARIANCES FROM THE PLANS SHALL BE COMMUNICATED TO THE ENGINEER TO FACILITATE CHANGES TO CONSTRUCTION DRAWINGS AS REQUIRED.

#### EROSION AND SEDIMENT CONTROL NOTES

TEMPORARY EROSION/SEDIMENT CONTROL PRIOR TO COMPLETION OF FINAL IMPROVEMENTS SHALL BE INSTALLED BY CONTRACTOR OR QUALIFIED PERSON AS INDICATED BELOW:

- 1. ALL REQUIREMENTS OF THE CITY, COUNTY AND STATE "STORM WATER STANDARDS" MUST BE INCORPORATED INTO THE DESIGN AND CONSTRUCTION OF THE PROPOSED GRADING/IMPROVEMENTS CONSISTENT WITH THE APPROVED STORM WATER POLLUTION PREVENTION PLAN (SWPPP), WATER QUALITY TECHNICAL REPORT (WQTR), AND/ OR WATER POLLUTION CONTROL PLAN (WPCP).
- 2. A GRAVEL BAG SILT BASIN SHALL BE INSTALLED IMMEDIATELY UPSTREAM OF STORM DRAIN INLETS AS INDICATED ON DETAILS.
- 3. FOR INLETS LOCATED AT SUMPS ADJACENT TO TOP OF SLOPES. THE CONTRACTOR SHALL INSURE WATER DRAINING TO THE SUMP IS DIRECTED INTO THE INLET AND A MINIMUM OF 1.00' FREEBOARD EXISTS AND IS MAINTAINED ABOVE THE TOP OF THE INLET. IF FREEBOARD IS NOT PROVIDED BY GRADING SHOWN ON THESE PLANS THE CONTRACTOR SHALL PROVIDE IT VIA TEMPORARY MEASURES, I.E. GRAVEL BAGS OR DIKES.
- 4. THE CONTRACTOR OR QUALIFIED PERSON SHALL BE RESPONSIBLE FOR CLEANUP OF SILT AND MUD ON ADJACENT STREET(S) AND STORM DRAIN SYSTEM DUE TO CONSTRUCTION ACTIVITY.
- 5. THE CONTRACTOR OR QUALIFIED PERSON SHALL CHECK AND MAINTAIN ALL LINED AND UNLINED DITCHES AFTER EACH RAINFALL.
- 6. THE CONTRACTOR SHALL REMOVE SILT AND DEBRIS AFTER EACH MAJOR RAINFALL.
- 7. THE CONTRACTOR SHALL MAINTAIN EQUIPMENT AND WORKERS FOR EMERGENCY WORK AT ALL TIMES DURING THE RAINY SEASON. MATERIALS NECESSARY FOR EMERGENCY MEASURES SHALL BE STOCKPILED ON SITE AT CONVENIENT LOCATIONS TO FACILITATE RAPID CONSTRUCTION OF TEMPORARY DEVICES WHEN RAIN IS IMMINENT.
- 8. THE CONTRACTOR IS RESPONSIBLE FOR RESTORING ALL EROSION/SEDIMENT CONTROL DEVICES TO WORKING ORDER TO THE SATISFACTION OF THE CITY/COUNTY/STATE ENGINEER OR RESIDENT ENGINEER FOLLOWING ANY RUN-OFF PRODUCING RAINFALL.
- 9. THE CONTRACTOR SHALL INSTALL ADDITIONAL EROSION/SEDIMENT CONTROL MEASURES AS REQUIRED BY THE RESIDENT ENGINEER DUE TO UNCOMPLETED GRADING OPERATIONS OR UNFORESEEN CIRCUMSTANCES.
- 10. THE CONTRACTOR SHALL BE RESPONSIBLE AND TAKE NECESSARY PRECAUTIONS TO PREVENT PUBLIC TRESPASS ONTO AREAS WHERE IMPOUNDED WATERS CREATE A HAZARDOUS CONDITION.
- 11. ALL EROSION/SEDIMENT CONTROL MEASURES PROVIDED PER THE APPROVED GRADING PLAN SHALL BE INCORPORATED HERON. ALL EROSION/SEDIMENT CONTROL FOR INTERIM CONDITIONS SHALL BE DONE TO THE SATISFACTION OF THE RESIDENT ENGINEER.
- 12. UPON COMPLETION OF WORK EACH DAY, GRADED AREAS AROUND THE PROJECT PERIMETER MUST DRAIN AWAY FROM THE FACE OF THE
- 13. ALL REMOVABLE PROTECTIVE DEVICES SHOWN SHALL BE IN PLACE AT THE END OF EACH WORKING DAY WHEN RAIN IS IMMINENT.
- 14. GRADING, INCLUDING CLEARING AND GRUBBING SHALL ONLY BE CONDUCTED IN AREAS WHERE THE CONTRACTOR OR QUALIFIED PERSON CAN PROVIDE EROSION/SEDIMENT CONTROL MEASURES.

### ROW GROUND CONSTRUCTION NOTES:

- THE CONTRACTOR SHALL REMOVE/CLEAN ALL DEBRIS, NAILS, STAPLES, OR NON-USED
- VERTICALS OFF THE POLE.
- 2. ALL WORK SHALL BE IN ACCORDANCE WITH MUNICIPAL, COUNTY, STATE, AND FEDERAL

#### STANDARDS AND REGULATIONS.

3. THE CONTRACTOR SHALL CALL LOCAL UNDERGROUND LOCATE SERVICE THREE WORKING DAYS

#### BEFORE ANY CONSTRUCTION IS STARTED

- 4. ALL EXISTING LANDSCAPING SHALL BE RESTORED TO ORIGINAL OR BETTER CONDITION.
- 5. ALL EQUIPMENT SHALL BE BONDED.
- 6. IF A METERING CABINET IS INSTALLED, A MINIMUM 3' CLEARANCE IS REQUIRED AT DOOR OPENING.
- 7. IF A METERING CABINET IS INSTALLED, THE CONTRACTOR SHALL CAULK THE CABINET BASE AT THE PAD.

#### STANDARD GROUNDING NOTES:

- 1. GROUND SHALL BE TESTED AT 25 OHMS OR LESS.
- 2. GROUND RODS SHALL BE 5/8"X8'. ATTACHMENT TO GROUND RODS SHALL BE EXOTHERMIC WELD OR UL LISTED DIRECT BURY CLAMP BELOW GRADF.
- 3. BURIED GROUND AND BONDING WIRE SHALL BE #6 AWG.
- 4. MOLDING SHALL BE STAPLED EVERY 1' AND AT EACH END.

#### STANDARD CONDUIT NOTES:

- 1. SCHEDULE 40 CONDUIT SHALL BE USED UNDERGROUND.
- 2. SCHEDULE 80 CONDUIT SHALL BE USED FOR RISERS.
- 3. RISERS SHALL BE ATTACHED TO POLE WITH STANDARD U-CLAMPS AND LAG SCREWS.
- 4. RISER U-CLAMPS TO BE INSTALLED EVERY 5'.
- 5. FOR U/G POWER INSTALLATIONS, 2" SDR-11 RED CONDUIT SHALL BE UTILIZED.
- 6. GROUND WIRE MOLDING STAPLES MAY BE BE UTILIZED FOR ATTACHING CONDUIT LESS THAN 1" DIAMETER.
- 7. ALL CONDUIT SHALL BE PROOFED WITH A MANDREL AND EQUIPPED WITH A PULL ROPE OR MULE TAPE.

#### STANDARD TRENCHING NOTES:

- 1. A MINIMUM OF 2'-6" OF COVER SHALL BE MAINTAINED OVER ALL ELECTRICAL CONDUITS.
- 2. A MINIMUM OF 4'-0" OF COVER SHALL BE MAINTAINED OVER ALL COMMUNICATIONS CONDUITS.
- 3. IN STREETS, SLURRY TO GRADE AND MILL DOWN 1-1/2" FOR AC CAP.
- 4. IN DIRT, SLURRY TO 18" FROM GRADE AND FILL WITH 95% COMPACTION NATIVE SOIL FOR BALANCE.
- 5. WARNING TAPE SHALL BE INSTALLED 1'-O" ABOVE ALL CONDUITS. #18 WARNING TAPE SHALL BE INSTALLED ABOVE GROUND RING.

#### ROW UTILITY POLE CONSTRUCTION NOTES:

- 1. BOLT THREADS SHALL NOT PROTRUDE MORE THAN 1-1/2".
- 2. HOLES LEFT IN POLE DUE TO REARRANGEMENT OF CLIMBERS SHALL BE FILLED.
- 3. CLIMB STEPS ADJACENT TO CONDUIT SHALL HAVE EXTENDED STEPS.
- 4. CABLE SHALL NOT IMPEDE 15" CLEAR SPACE OFF POLE FACE (12:00).
- 5. 90° SHORT SWEEPS SHALL BE USED UNDER ANTENNA ARM. CABLES MUST TRANSITION ON THE INSIDE OR BOTTOM OF ARMS. (NO CABLE SHALL BE INSTALLED ON TOP OF ARMS.)
- 6. CABLE CLAMPS SHALL BE UTILIZED TO SECURE CABLE TO
  ARMS; 2" CARRIER CABLE ID TAGS SHALL BE PLACED ON BOTH SIDES OF
- 7. UTILIZE A 90° CONNECTOR AT CABLE CONNECTION TO ANTENNA.
- 8. 1/2" CABLE TO BE UTILIZED UNLESS NOTED OTHERWISE.
- 9. VOIDS AROUND CABLES AT CONDUIT OPENINGS SHALL BE FILLED WITH FOAM SEALANT TO PREVENT WATER INTRUSION.







DRAWN BY:	JRR
DATE:	06/04/2019

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T IS A VIOLATION OF LAW FOR ANY PERSON UNLESS THEY ARE ACTING UNDER THE DIRECTION OF A LICENSED PROFESSIONAL ENGINEER, TO ALTER THIS DOCUMENT.

### WS-LNCL-RL01

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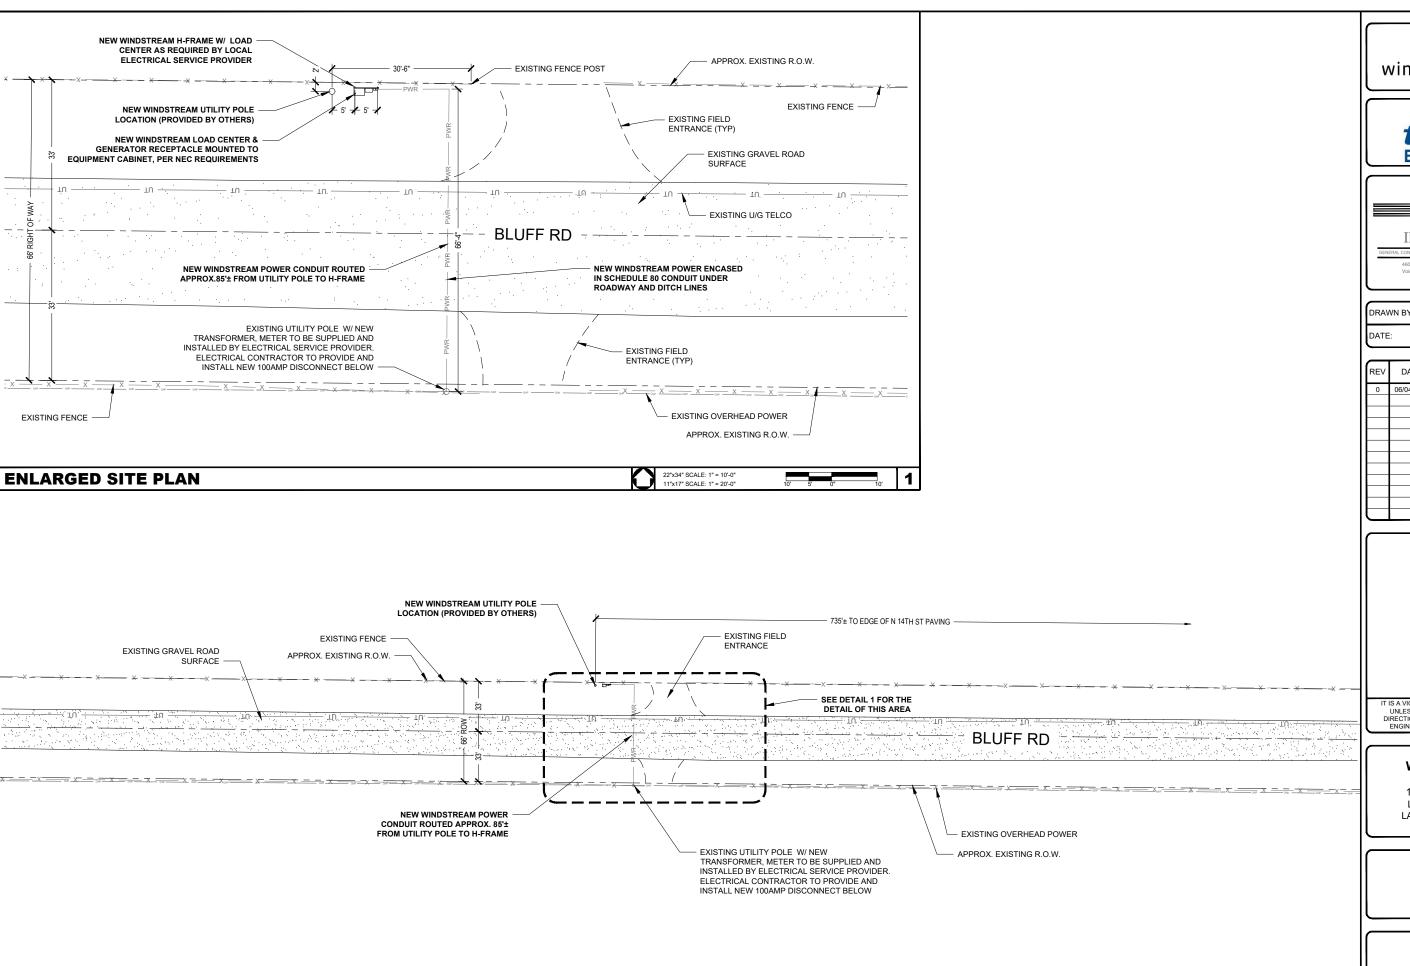
SHEET TITLE

GENERAL

NOTES

SHEET NUMBER

**T-2** 



**OVERALL SITE PLAN** 

windstream





DRAWN BY: JRR

DATE: 06/04/2019

REV	DATE	DESCRIPTION	BY
0	06/04/2019	FINAL CD	JRR

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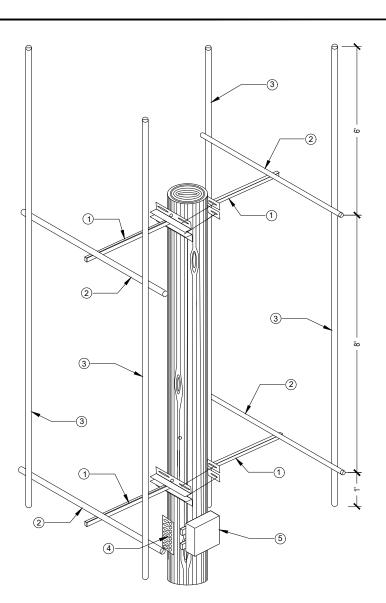
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SITE PLAN


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**C-1** 

22"x34" SCALE: 1" = 30'-0"



- 1 FOUR 2.5' WOOD POLE STAND-OFFS, TWO MOUNTED BACK-TO-BACK AT 99', ONE AT 45° AND ONE AT 225° EACH SECURED TO THE POLE WITH TWO 4" GALVANIZED LAG BOLTS. THE STAND-OFFS WILL BE CONNECT TO EACH OTHER WITH FOUR 5/8" ALL-THREAD AND GALVANIZED HARDWARE. THE OTHER TWO WOOD POLE STAND-OFFS WILL BE MOUNTED AN 91' IN THE SAME MANNER AS THE TOP STAND-OFFS.
- 2) HORIZONTAL PIPE: FOUR 1.66" OD X 5' LONG PIPES (MADE BY CUTTING A 10' LENGTHS OF PIPE IN HALF) WILL BE MOUNTED ONE EACH TO EACH OF THE FOUR 2.5' WOOD POLE STAND-OFF MOUNTS INSTALLED IN THE PREVIOUS STEP. THE CENTER OF EACH HORIZONTAL PIPE SHOULD ATTACH TO END OF EACH OF THE STAND-OFF MOUNTS UTILIZING A PIPE CROSSOVER MOUNT (PN-SINCLAMPO17) TO MAKE THE CONNECTION.
- ③ VERTICAL PIPES: FOUR VERTICAL 1.66" OD X 15'GALVANIZED PIPES ARE USED TO COMPLETE THE POLE TOP MOUNT. ONE EACH OF THE VERTICAL PIPES WILL ATTACH TO THE ENDS OF THE UPPER AND LOWER HORIZONTAL PIPES. EACH VERTICAL PIPE SHOULD ATTACH 2" IN FROM THE END OF THE HORIZONTAL PIPES WITH ~6' OF PIPE EXTENDING ABOVE THE UPPER HORIZONTAL PIPE AND ~12" OF PIPE EXTENDING BELOW THE LOWER HORIZONTAL PIPE. EACH VERTICAL PIPE WILL BE CONNECTED TO THE HORIZONTAL PIPES WITH TWO PIPE CROSS-OVER MOUNTS (PNSINCLAMPO17) ONE ON THE TOP HORIZONTAL PIPE AND ONE ON THE BOTTOM.
  DURING FINAL ASSEMBLE A LEVEL SHOULD BE USED TO ASSURE THAT THE VERTICAL PIPES ARE INSTALL PLUMB IN EACH DIRECTION.
- 4 PTMP RAD CENTER GROUND BAR SHOULD BE ATTACHED TO THE POLE UTILIZING THE INCLUDED ISOLATION MOUNTS AND HARDWARE, 12" BELOW THE BOTTOM 2.5' STAND-OFF MOUNTS.
- (5) PTMP RAD CENTER OUTDOOR ENCLOSURE (PN-AM32P-2625-16RU) SHOULD BE ATTACHED TO THE POLE 1' ABOVE THE BOTTOM MOUNT. A 16" UNISTRUT SHOULD BE SECURED TO THE POLE USING A 4" GALVANIZED LAG BOT. THE ENCLOSURE SHOULD BE MOUNTED TO THE UNISTRUT UTILIZING THE SPRING NUT AND BOLT

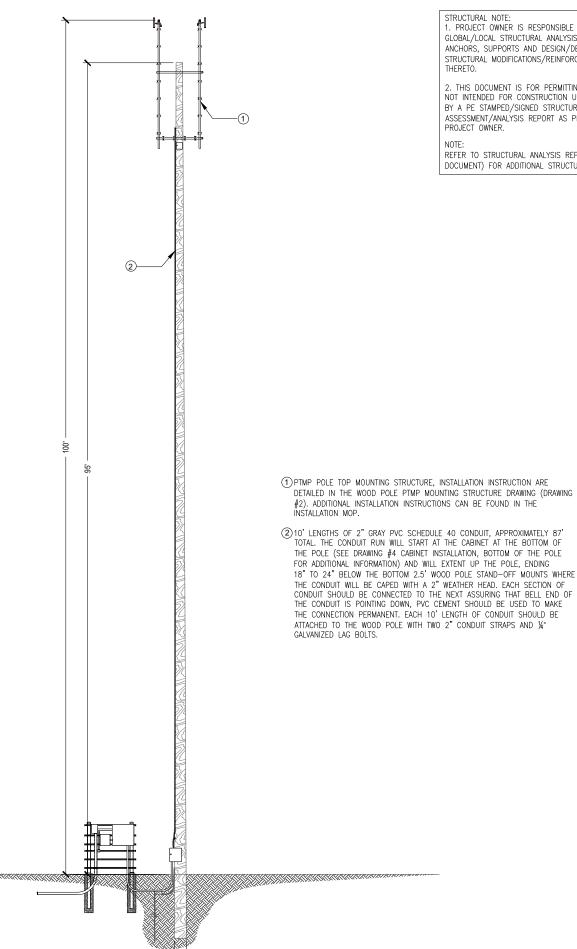

STRUCTURAL NOTE:

. PROJECT OWNER IS RESPONSIBLE FOR PROVIDING A GLOBAL/LOCAL STRUCTURAL ANALYSIS OF EQUIPMENT ANCHORS, SUPPORTS AND DESIGN/DETAILING OF ANY STRUCTURAL MODIFICATIONS/REINFORCEMENT REQUIRED

2. THIS DOCUMENT IS FOR PERMITTING ONLY AND IS NOT INTENDED FOR CONSTRUCTION UNLESS ACCOMPANIED BY A PE STAMPED/SIGNED STRUCTURAL ASSESSMENT/ANALYSIS REPORT AS PROVIDED BY THE PROJECT OWNER.

REFER TO STRUCTURAL ANALYSIS REPORT (SEPARATE DOCUMENT) FOR ADDITIONAL STRUCTURAL INFORMATION.







DRAWN BY:	JRR
DATE:	06/04/2019

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0	06/04/2019	FINAL CD	JRR


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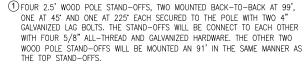
### WS-LNCL-RL01

1244 BLUFF ROAD LINCOLN, NE 68531 LANCASTER COUNTY

SHEET TITLE **ELEVATION DETAILS** 

SHEET NUMBER



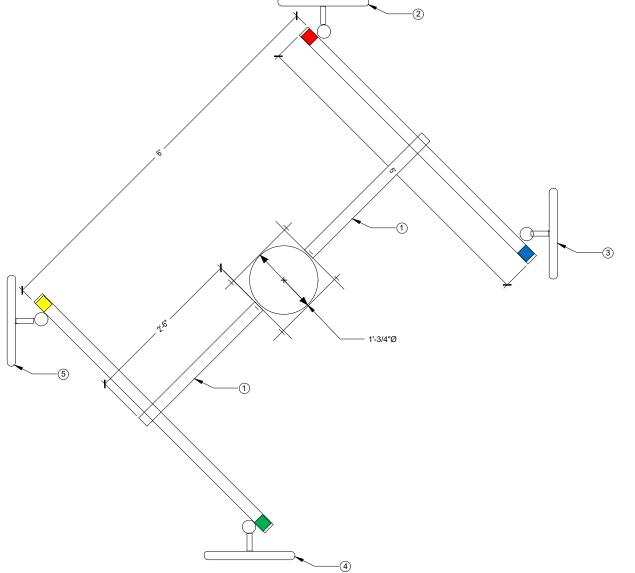

- ② AZIMUTH 01 (0' NORTH) HAS A SINGLE BS AT 99'ACL, 0' AZIMUTH WITH 0' PHYSICAL DOWN TILT AND PROVISIONED WITH A 40 MHZ WIDE CHANNEL IN THE 5.8 GHZ RANGE (SEE RFDS FOR SPECIFIC FREQUENCY. AZIMUTH 01 (NORTH) IS LABELED WITH RED TAPE, THE TOP OF THE PIPE IS MARKED WITH A SINGLE WRAP OF RED TAPE. THE BS SHOULD HAVE A SINGLE WRAP OF RED TAPE ON EACH END OF THE FOLLOWING CABLES; THE JUMPER CABLE BETWEEN THE LPU AND THE BS, THE VERTICAL CABLE RUN BETWEEN THE TOP LPU AND THE BOTTOM LPU AND THE JUMPER BETWEEN THE BOTTOM LPU AND POE SWITCH PORT.
- (3) AZIMUTH 02 (90° EAST) HAS A SINGLE BS AT 99'ACL, 90° AZIMUTH WITH 0° PHYSICAL DOWN TILT AND PROVISIONED WITH A 40 MHZ WIDE CHANNEL IN THE 5.8 CHZ RANGE (SEE REDS FOR SPECIFIC FREQUENCY. AZIMUTH 02 (EAST) IS LABELED WITH BLUE TAPE, THE TOP OF THE PIPE IS MARKED WITH A SINGLE WRAP OF BLUE TAPE. THE BS SHOULD HAVE A SINGLE WRAP OF BLUE TAPE ON EACH END OF THE FOLLOWING CABLES; THE JUMPER CABLE BETWEEN THE LPU AND THE BS, THE VERTICAL CABLE RUN BETWEEN THE TOP LPU AND THE BOTTOM LPU AND THE JUMPER BETWEEN THE BOTTOM LPU AND POE SWITCH PORT.
- (4) AZIMUTH 03 (180° SOUTH) HAS A SINGLE BS AT 99'ACL, 180° AZIMUTH WITH 0° PHYSICAL DOWN TILT AND PROVISIONED WITH A 40 MHZ WIDE CHANNEL IN THE 5.8 GHZ RANGE (SEE RFDS FOR SPECIFIC FREQUENCY. AZIMUTH 03 (SOUTH) IS LABELED WITH GREEN TAPE, THE TOP OF THE PIPE IS MARKED WITH A SINGLE WRAP OF GREEN TAPE. THE BS SHOULD HAVE A SINGLE WRAP OF GREEN TAPE ON EACH END OF THE FOLLOWING CABLES; THE JUMPER CABLE BETWEEN THE LPU AND THE BS, THE VERTICAL CABLE RUN BETWEEN THE TOP LPU AND THE BOTTOM LPU AND THE JUMPER BETWEEN THE BOTTOM LPU AND POE SWITCH PORT.
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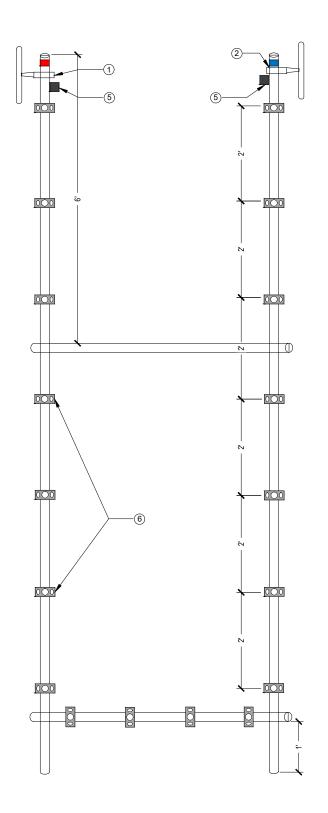
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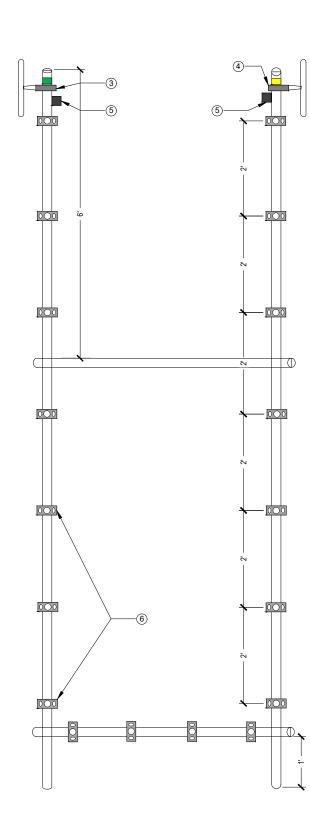
SHEET TITLE
ANTENNA LAYOUT
DETAILS

SHEET NUMBER

**C**-3

1





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- (5) POLE TOP LIGHTNING PROTECTION UNITS (LPU): EACH BASE STATION WILL HAVE ONE POLE TOP LPU MOUNTED 2" BELOW THE BS MOUNTING CLAMP 180' OPPOSITE THE BS. FOLLOW THE CABLE INSTALLATION INSTRUCTIONS INCLUDED WITH THE LPU WHEN CABLING THE LPU.
- (6) THREE HOLE UNIVERSAL SNAP—IN ADAPTORS SHOULD BE ATTACHED TO EACH OF THE VERTICAL PIPES EVERY 2', AND THE LOWER HORIZONTAL PIPE EVERY 1' TO ACCOMMODATE THE APPROPRIATE SNAP HANGERS AND GROMMETS FOR PROPER CABLE SUPPORT. NOTE: ALTHOUGH SHOWN IN THE PHOTO FOR ILLUSTRATIVE PURPOSES, VERTICAL PIPES WITHOUT BASE STATION SHOULD NOT HAVE UNIVERSAL SNAP—IN ADAPTORS INSTALLED.







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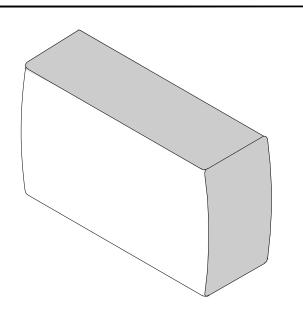
SHEET TITLE
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DETAILS

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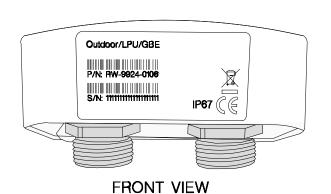
**C-4** 

**NEW STRUCTURE DETAILS** 

1



	BAS	E STATION
ı	MANUF:	RADWIN
ı	PART #:	RW-5BG5-0649
ı	HEIGHT:	8.86"
ı	WIDTH:	14.01"
l	DEPTH:	3.7"
l	WEIGHT:	7.28 LBS



LIGHTN	ING PROTECTION
MANUF:	RADWIN
PART #:	RW-9924-0106
HEIGHT:	2.04"
WIDTH:	3.87"
DEPTH:	1.88"
WEIGHT:	0.49 LBS



CABINET	
_	ADINE
MANUF:	WESTELL
PART #:	BXM1019-NHE3
HEIGHT:	22.5"
WIDTH:	25.5"
DEPTH:	27.8"
WEIGHT:	70.00 LBS







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1244 BLUFF ROAD LINCOLN, NE 68531 LANCASTER COUNTY

SHEET TITLE
EQUIPMENT
DETAILS


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5


**D-1** 


# 1 LIGHTNING PROTECTOR


# 2 | WESTELL BOXER OUTDOOR CABINET

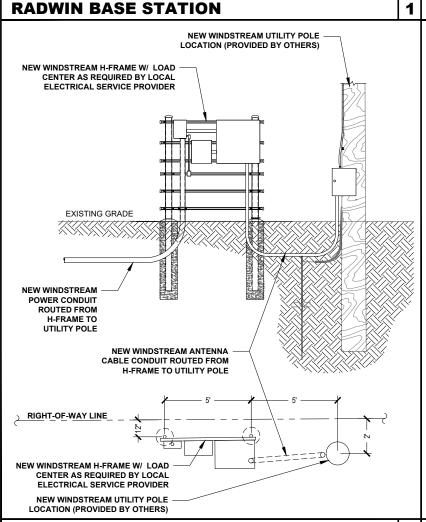

**DETAIL RACK ELEVATION** 

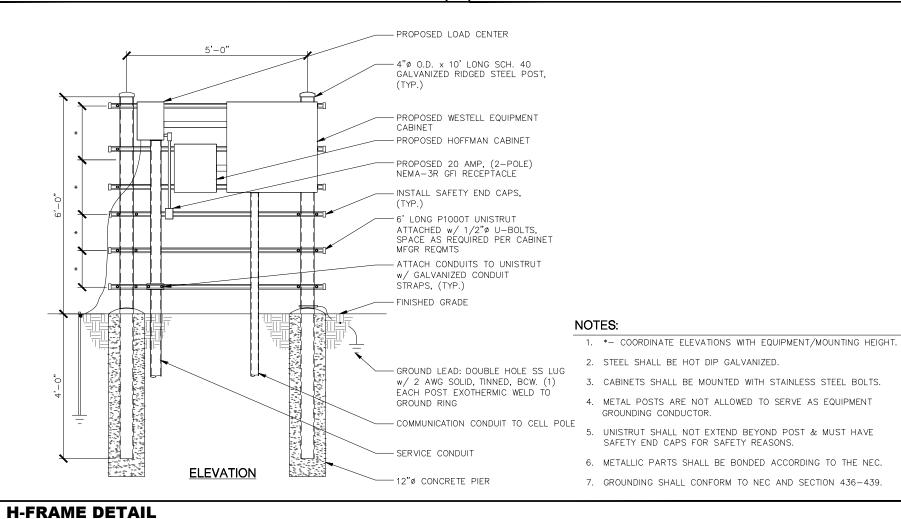

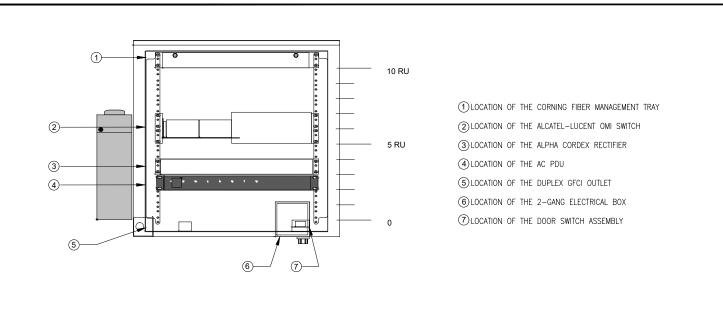

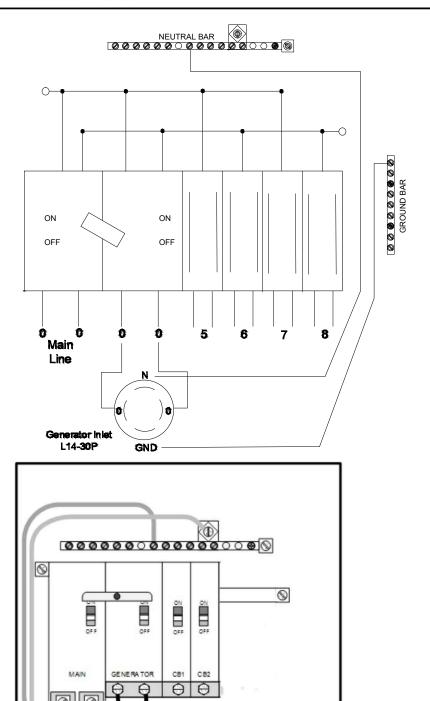







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DATE:	06/04/2019

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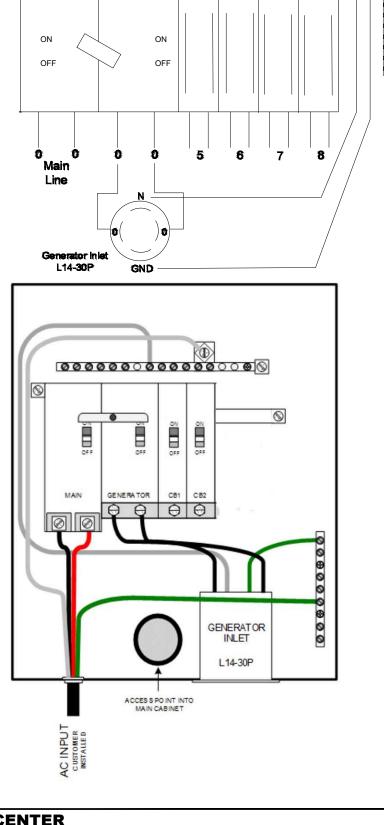
1244 BLUFF ROAD LINCOLN, NE 68531 LANCASTER COUNTY

SHEET TITLE **ELECTRICAL &** GROUNDING **DETAILS** 

SHEET NUMBER

3


**E-1** 



**NOT USED** 

**CABINET DETAIL** 

2 LOAD CENTER

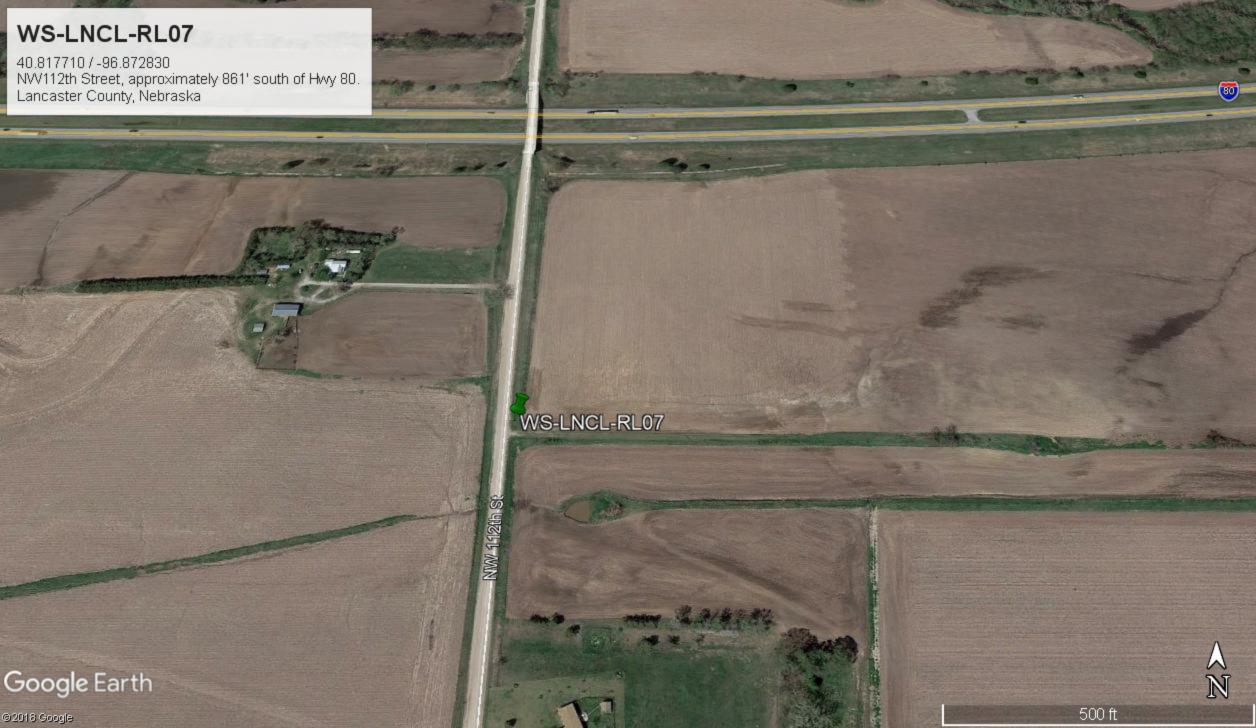

# WS-LNCL-RL07

**462 NW 112TH STREET** LINCOLN, NE 68528

# SITE INFORMATION

SITE ID: 462 NW 112TH STREET LINCOLN, NE 68528 ADDRESS: COUNTY: LANCASTER COUNTY LATITUDE: LONGITUDE:

JURISDICTION: LANCASTER COUNTY

#### **CONTACTS**

PROFESSIONAL ENGINEER:

PROJECT MANAGER

IRISH TOWER, LLC 4603 BERMUDA DRIVE SUGAR LAND, TEXAS 77479

PROPERTY OWNER:

# **GENERAL NOTES**

THE FACILITY IS NOT FOR HUMAN HABITATION. A TECHNICIAN WILL VISIT THE SITE AS REQUIRED FOR ROUTINE MAINTENANCE. THE PROJECT WILL NOT RESULT IN ANY SIGNIFICANT DISTURBANCE OR EFFECT ON DRAINAGE; NO SANITARY SEWER SERVICE, POTABLE WATER, OR TRASH DISPOSAL IS REQUIRED AND NO COMMERCIAL SIGNAGE IS NEW. THE SITE LOCATION IS SUBJECT TO MOVING, UP TO 10 FROM PROPOSED LOCATION, AS NEEDED TO KEEP WITHIN PUBLIC ROW, AVOID EXISTING UTILITY LINES, AND AVOID LINE-OS-SIGHT OBSTRUCTIONS WITH BOTH FOOT AND AUTOMOTIVE TRAFFIC. CONTRACTOR SHALL NOTIFY ENGINEER OF RECORD PRIOR TO ANY CHANGES.



# PROJECT DESCRIPTION

THESE DRAWINGS DEPICT AN UTILITY POLE WITH ANTENNA INSTALLATION TO PROVIDE HIGH SPEEL NTERNET SERVICE IN RURAL AREAS. THIS INSTALLATION SHALL CONSIST OF THE PLACEMENT OF A NEW POLE, FOUR (4) ANTENNAS, ONE (1) MICROWAVE DISH AND RADIO, ONE (1) CONCEALMENT CABINET AND ASSOCIATED ELECTRICAL COMPONENTS AND MOUNTING BRACKETS AS REQUIRED

# **ENGINEERING**

ALL WORK AND MATERIALS SHALL BE PERFORMED AND INSTALLED IN

2011 NATIONAL ELECTRICAL CODE 2012 INTERNATIONAL BUILDING CODE 2012 INTERNATIONAL MECHANICAL CODE 2012 INTERNATIONAL PLUMBING CODE 2012 LIFE SAFETY CODE (NFPA 101)

2012 INTERNATIONAL FIRE CODE CITY AND/OR COUNTY ORDINANCES LOCAL BUILDING CODE(S) ANSI EIA/TIA 222-G

SHEET NO:	SHEET TITLE	
T-1	TITLE SHEET	
T-2	GENERAL NOTES	
C-1	SITE PLANS	
C-2	ELEVATION DETAILS	
C-3	ANTENNA LAYOUT DETAILS	
C-4	STRUCTURE DETAILS	
D-1	EQUIPMENT DETAILS	
E-1	ELECTRICAL & GROUNDING DETAILS	

CONTRACTOR SHALL VERIFY ALL PLANS & CONTRACTOR STALL VENIET ALE PLANS & EXISTING DIMENSIONS & CONDITIONS ON THE JOB SITE & SHALL IMMEDIATELY NOTIFY THE ARCHITECT OR ENGINEER IN WRITING OF ANY DISCREPANCIES BEFORE PROCEEDING WITH THE WORK OR BE RESPONSIBLE FOR SAME.









DRAWN BY:	JRR
DATE:	06/12/2019

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Α	06/06/2019	99% CD	JRR
0	06/12/2019	100% FINAL CD	JHR

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#### WS-LNCL-RL07

462 NW 112TH STREET LINCOLN, NE 68528 LANCASTER COUNTY

SHEET TITLE

TITLE SHEET

SHEET NUMBER

#### GENERAL NOTES

- 1. THE CONTRACTOR SHALL BE RESPONSIBLE FOR SURVEY MONUMENTS AND/OR VERTICAL CONTROL BENCHMARKS WHICH ARE DISTURBED OR DAMAGED BY CONSTRUCTION. A LAND SURVEYOR MUST FIELD LOCATE, REFERENCE, AND/OR PRESERVE ALL HISTORICAL OR CONTROLLING MONUMENTS PRIOR TO ANY EARTHWORK. IF DAMAGED, SUCH MONUMENTS SHALL BE REPLACED WITH APPROPRIATE MONUMENTS BY A LAND SURVEYOR. A CORNER RECORD OR RECORD OF SURVEY, AS APPROPRIATE, SHALL BE FILED AS REQUIRED BY THE PROFESSIONAL LAND SURVEYORS ACT.
- 2. IMPORTANT NOTICE: CONTRACTOR SHALL CALL LOCAL UNDERGROUND LOCATE SERVICE THREE WORKING DAYS BEFORE ANY CONSTRUCTION.
- 3. CONTRACTOR SHALL BE RESPONSIBLE FOR LOCATING ALL EXISTING UTILITIES WITHIN PROPOSED EXCAVATIONS AND MUST MAINTAIN MINIMUM VERTICAL AND HORIZONTAL CLEARANCES AS CALLED FOR BY LOCAL CODES AND/OR ORDINANCES.
- 4. CONTRACTOR IS RESPONSIBLE FOR REPAIR AND/OR REPLACEMENT OF ANY EXISTING STRUCTURES OR LANDSCAPING DAMAGED DURING CONSTRUCTION.
- 5. CONTRACTOR SHALL REPLACE OR REPAIR ALL TRAFFIC SIGNAL LOOPS, CONDUIT, AND LANE STRIPING DAMAGED DURING CONSTRUCTION.
- 6. THIS PROJECT WILL BE INSPECTED BY ENGINEERING AND FIELD ENGINEERING DIVISION.
- 7. ANY MANHOLES OR COVERS INSTALLED AS PART OF THIS PROJECT SHALL BE LABELED COMMUNICATIONS.
- 8. THE CONTRACTOR SHALL BE RESPONSIBLE FOR IMPLEMENTATION OF AN EROSION CONTROL PLAN WHICH MEETS ALL APPLICABLE REQUIREMENTS OF STATE AND LOCAL AGENCIES HAVING JURISDICTION.
- 9. THE CONTRACTOR SHALL MAINTAIN MATERIALS AND EQUIPMENT ON SITE FOR UNFORESEEN SITUATIONS INCLUDING DAMAGE TO UNDERGROUND WATER, SEWER, AND STORM DRAIN FACILITIES WHICH COULD GENERATE FLOWS ABLE TO CAUSE EROSION AND SEDIMENT POLITICION

#### SPECIAL NOTES

- 1. INDEMNIFICATION CLAUSE: THE CONTRACTOR AGREES AND SHALL: ASSUME SOLE AND COMPLETE RESPONSIBILITY OF THE JOB SITE CONDITIONS DURING THE COURSE OF CONSTRUCTION OF THIS PROJECT, INCLUDING THE SAFETY OF ALL PERSONS AND PROPERTIES. THESE REQUIREMENTS SHALL APPLY CONTINUOUSLY AND NOT BE LIMITED TO NORMAL WORKING HOURS AND CONDITIONS. THE CONTRACTOR FURTHER AGREES TO DEFEND INDEMNITY AND HOLD OWNER, REPRESENTATIVES, AND ENGINEERS HARMLESS FROM ANY AND ALL LIABILITY, REAL OR ALLEGED IN CONNECTION WITH THE PERFORMANCE OF THE WORK ON THIS PROJECT.
- 2. PRIOR TO START OF CONSTRUCTION AND THROUGH PROJECT COMPLETION, THE CONTRACTOR SHALL REMAIN IN FULL COMPLIANCE WITH CURRENT FEDERAL, STATE, AND LOCAL OCCUPATIONAL HEALTH AND SAFETY REGULATIONS.
- 3. ALL WORK SHALL CONFORM TO THE LATEST STANDARD "SPECIFICATIONS FOR PUBLIC WORKS CONSTRUCTION" AS ADOPTED BY THE CITY, COUNTY OR STATE AND AS MODIFIED BY STANDARD PLANS AND ADDENDUMS.
- 4. ALL UTILITIES AND OTHER FACILITIES DEPICTED ON THE PLANS ARE BASED ON A SEARCH OF AVAILABLE RECORDS AND FIELD OBSERVATIONS. THE CONTRACTOR SHALL VERIFY PRIOR TO CONSTRUCTION START AND USE EXTREME CARE AND PROTECTIVE MEASURES TO AVOID DAMAGE TO ANY FACILITIES WETHER OR NOT INDICATED ON THESE PLANS. THE CONTRACTOR IS RESPONSIBLE FOR THE PROTECTION OF ALL FACILITIES WITHIN THE LIMITS OF WORK, WHETHER OR NOT DEPICTED ONT THESE PLANS.
- 5. THE CONTRACTOR SHALL BE RESPONSIBLE FOR NOTIFICATION OF ANY CITY, COUNTY OR STATE ENGINEER INSPECTION DEPARTMENT A MINIMUM TWO DAYS PRIOR TO COMMENCEMENT OF ACTIVITY REQUIRING THEIR INVOLVEMENT.
- 6. THE EXPIRATION OF THE PERMIT FOR THIS PROJECT SHALL BE SPECIFIED BY THE LOCAL AUTHORITY HAVING JURISDICTION.
- 7. ALL UNDERGROUND CONDUITS PLACED AS PART OF THIS PROJECT MUST HAVE A MINIMUM COVER OF 48 INCHES UNLESS OTHERWISE APPROVED.
- 8. THE CONTRACTOR SHALL TUNNEL ALL CURB AND GUTTERS AND BORE ALL CONCRETE DRIVEWAYS AND WALKWAYS AT THE DIRECTION OF THE CITY, COUNTY OR STATE ENGINEER HAVING JURISDICTION.
- 9. ALL PAVEMENT CUT OR DAMAGED AS PART OF THIS PROJECT SHALL BE REPLACED AT THE DIRECTION OF THE CITY, COUNTY OR STATE ENGINEER HAVING JURISDICTION.
- 10. ALL SHRUBS, PLANTS OR TREES DAMAGED OR DISTURBED DURING THE COURSE OF THE WORK, SHALL BE REPLANTED AND/OR REPLACED SO AS TO RESTORE THE WORK SITE TO ITS ORIGINAL CONDITION.
- 11. THE CONTRACTOR SHALL BE RESPONSIBLE FOR PROCESSING OF ALL APPLICANT PERMIT FORMS ALONG WITH REQUIRED LIABILITY INSURANCE FORMS CLEARLY DEMONSTRATING OWNER, OWNER REPRESENTATIVES, ENGINEER, AND CITY, COUNTY OR STATE ARE ALSO INSURED WITH THE REQUIRED LIABILITY INSURANCE FOR THIS CONSTRUCTION PROJECT.
- 12. ALL SUBSURFACE STRUCTURES INCLUDING BUT NOT LIMITED TO VAULTS, PEDESTALS, AND CONDUITS SHALL BE AS SPECIFIED IN THESE PLANS OR AS SPECIFIED BY THE ENGINEER. ANY DEVIATIONS SHALL BE APPROVED BY THE ENGINEER IN WRITING PRIOR TO INSTALLATION.
- 13. THE CONTRACTOR IS RESPONSIBLE FOR VERIFICATION OF ALL EXISTING UTILITIES, INCLUDING BUT NOT LIMITED TO SEWER LATERALS AND WATER SERVICES, BOTH VERTICAL AND HORIZONTAL, PRIOR TO COMMENCING IMPROVEMENT OPERATIONS.
- 14. THE CONTRACTOR IS RESPONSIBLE FOR COMPLETION OF EXPLORATION EXCAVATIONS CONDUCTED FOR THE PURPOSE OF LOCATING EXISTING FACILITIES SUFFICIENTLY AHEAD OF CONSTRUCTION TO PERMIT REVISIONS TO PLANS AS REQUIRED.

  15. LOCATIONS OF EXISTING LITHITIES ON THESE PLANS ARE BASED LIPON EXISTING RECORD
- 15. LOCATIONS OF EXISTING UTILITIES ON THESE PLANS ARE BASED UPON EXISTING RECORDS VERIFIED WHERE POSSIBLE WITH FIELD TIES. CONTRACTOR IS RESPONSIBLE FOR VERIFICATION OF LOCATIONS SHOWN, BOTH HORIZONTAL AND VERTICALLY. PRIOR TO CONSTRUCTION, SUBSTANTIAL VARIANCES FROM THE PLANS SHALL BE COMMUNICATED TO THE ENGINEER TO FACILITATE CHANGES TO CONSTRUCTION DRAWINGS AS REQUIRED.

#### EROSION AND SEDIMENT CONTROL NOTES

TEMPORARY EROSION/SEDIMENT CONTROL PRIOR TO COMPLETION OF FINAL IMPROVEMENTS SHALL BE INSTALLED BY CONTRACTOR OR QUALIFIED PERSON AS INDICATED BELOW:

- 1. ALL REQUIREMENTS OF THE CITY, COUNTY AND STATE "STORM WATER STANDARDS" MUST BE INCORPORATED INTO THE DESIGN AND CONSTRUCTION OF THE PROPOSED GRADING/IMPROVEMENTS CONSISTENT WITH THE APPROVED STORM WATER POLLUTION PREVENTION PLAN (SWPPP), WATER QUALITY TECHNICAL REPORT (WQTR), AND/ OR WATER POLLUTION CONTROL PLAN (WPCP).
- 2. A GRAVEL BAG SILT BASIN SHALL BE INSTALLED IMMEDIATELY UPSTREAM OF STORM DRAIN INLETS AS INDICATED ON DETAILS.
- 3. FOR INLETS LOCATED AT SUMPS ADJACENT TO TOP OF SLOPES. THE CONTRACTOR SHALL INSURE WATER DRAINING TO THE SUMP IS DIRECTED INTO THE INLET AND A MINIMUM OF 1.00' FREEBOARD EXISTS AND IS MAINTAINED ABOVE THE TOP OF THE INLET. IF FREEBOARD IS NOT PROVIDED BY GRADING SHOWN ON THESE PLANS THE CONTRACTOR SHALL PROVIDE IT VIA TEMPORARY MEASURES, I.E. GRAVEL BAGS OR DIKES.
- 4. THE CONTRACTOR OR QUALIFIED PERSON SHALL BE RESPONSIBLE FOR CLEANUP OF SILT AND MUD ON ADJACENT STREET(S) AND STORM DRAIN SYSTEM DUE TO CONSTRUCTION ACTIVITY.
- 5. THE CONTRACTOR OR QUALIFIED PERSON SHALL CHECK AND MAINTAIN ALL LINED AND UNLINED DITCHES AFTER EACH RAINFALL.
- 6. THE CONTRACTOR SHALL REMOVE SILT AND DEBRIS AFTER EACH MAJOR RAINFALL.
- 7. THE CONTRACTOR SHALL MAINTAIN EQUIPMENT AND WORKERS FOR EMERGENCY WORK AT ALL TIMES DURING THE RAINY SEASON. MATERIALS NECESSARY FOR EMERGENCY MEASURES SHALL BE STOCKPILED ON SITE AT CONVENIENT LOCATIONS TO FACILITATE RAPID CONSTRUCTION OF TEMPORARY DEVICES WHEN RAIN IS IMMINENT.
- 8. THE CONTRACTOR IS RESPONSIBLE FOR RESTORING ALL EROSION/SEDIMENT CONTROL DEVICES TO WORKING ORDER TO THE SATISFACTION OF THE CITY/COUNTY/STATE ENGINEER OR RESIDENT ENGINEER FOLLOWING ANY RUN-OFF PRODUCING RAINFALL.
- 9. THE CONTRACTOR SHALL INSTALL ADDITIONAL EROSION/SEDIMENT CONTROL MEASURES AS REQUIRED BY THE RESIDENT ENGINEER DUE TO UNCOMPLETED GRADING OPERATIONS OR UNFORESEEN CIRCUMSTANCES.
- 10. THE CONTRACTOR SHALL BE RESPONSIBLE AND TAKE NECESSARY PRECAUTIONS TO PREVENT PUBLIC TRESPASS ONTO AREAS WHERE IMPOUNDED WATERS CREATE A HAZARDOUS CONDITION.
- 11. ALL EROSION/SEDIMENT CONTROL MEASURES PROVIDED PER THE APPROVED GRADING PLAN SHALL BE INCORPORATED HERON. ALL EROSION/SEDIMENT CONTROL FOR INTERIM CONDITIONS SHALL BE DONE TO THE SATISFACTION OF THE RESIDENT ENGINEER.
- 12. UPON COMPLETION OF WORK EACH DAY, GRADED AREAS AROUND THE PROJECT PERIMETER MUST DRAIN AWAY FROM THE FACE OF THE
- 13. ALL REMOVABLE PROTECTIVE DEVICES SHOWN SHALL BE IN PLACE AT THE END OF EACH WORKING DAY WHEN RAIN IS IMMINENT.
- 14. GRADING, INCLUDING CLEARING AND GRUBBING SHALL ONLY BE CONDUCTED IN AREAS WHERE THE CONTRACTOR OR QUALIFIED PERSON CAN PROVIDE EROSION/SEDIMENT CONTROL MEASURES.

#### ROW GROUND CONSTRUCTION NOTES:

- 1. THE CONTRACTOR SHALL REMOVE/CLEAN ALL DEBRIS, NAILS, STAPLES, OR NON-USED
- VERTICALS OFF THE POLE.
- 2. ALL WORK SHALL BE IN ACCORDANCE WITH MUNICIPAL, COUNTY, STATE, AND FEDERAL

#### STANDARDS AND REGULATIONS.

3. THE CONTRACTOR SHALL CALL LOCAL UNDERGROUND LOCATE SERVICE THREE WORKING DAYS

#### BEFORE ANY CONSTRUCTION IS STARTED

- 4. ALL EXISTING LANDSCAPING SHALL BE RESTORED TO ORIGINAL OR BETTER CONDITION.
- 5. ALL EQUIPMENT SHALL BE BONDED.
- 6. IF A METERING CABINET IS INSTALLED, A MINIMUM 3' CLEARANCE IS REQUIRED AT DOOR OPENING.
- 7. IF A METERING CABINET IS INSTALLED, THE CONTRACTOR SHALL CAULK THE CABINET BASE AT THE PAD.

#### STANDARD GROUNDING NOTES:

- 1. GROUND SHALL BE TESTED AT 25 OHMS OR LESS.
- 2. GROUND RODS SHALL BE 5/8"X8'. ATTACHMENT TO GROUND RODS SHALL BE EXOTHERMIC WELD OR UL LISTED DIRECT BURY CLAMP BELOW GRADF.
- 3. BURIED GROUND AND BONDING WIRE SHALL BE #6 AWG.
- 4. MOLDING SHALL BE STAPLED EVERY 1' AND AT EACH END.

#### STANDARD CONDUIT NOTES:

- 1. SCHEDULE 40 CONDUIT SHALL BE USED UNDERGROUND.
- 2. SCHEDULE 80 CONDUIT SHALL BE USED FOR RISERS.
- 3. RISERS SHALL BE ATTACHED TO POLE WITH STANDARD U-CLAMPS AND LAG SCREWS.
- 4. RISER U-CLAMPS TO BE INSTALLED EVERY 5'.
- 5. FOR U/G POWER INSTALLATIONS, 2" SDR-11 RED CONDUIT SHALL BE UTILIZED.
- 6. GROUND WIRE MOLDING STAPLES MAY BE BE UTILIZED FOR ATTACHING CONDUIT LESS THAN 1" DIAMETER.
- 7. ALL CONDUIT SHALL BE PROOFED WITH A MANDREL AND EQUIPPED WITH A PULL ROPE OR MULE TAPE.

#### STANDARD TRENCHING NOTES:

- 1. A MINIMUM OF 2'-6" OF COVER SHALL BE MAINTAINED OVER ALL ELECTRICAL CONDUITS.
- 2. A MINIMUM OF 4'-0" OF COVER SHALL BE MAINTAINED OVER ALL COMMUNICATIONS CONDUITS.
- 3. IN STREETS, SLURRY TO GRADE AND MILL DOWN 1-1/2" FOR AC CAP.
- 4. IN DIRT, SLURRY TO 18" FROM GRADE AND FILL WITH 95% COMPACTION NATIVE SOIL FOR BALANCE.
- 5. WARNING TAPE SHALL BE INSTALLED 1'-O" ABOVE ALL CONDUITS. #18 WARNING TAPE SHALL BE INSTALLED ABOVE GROUND RING.

#### ROW UTILITY POLE CONSTRUCTION NOTES:

- 1. BOLT THREADS SHALL NOT PROTRUDE MORE THAN 1-1/2".
- 2. HOLES LEFT IN POLE DUE TO REARRANGEMENT OF CLIMBERS SHALL BE FILLED.
- 3. CLIMB STEPS ADJACENT TO CONDUIT SHALL HAVE EXTENDED STEPS.
- 4. CABLE SHALL NOT IMPEDE 15" CLEAR SPACE OFF POLE FACE (12:00).
- 5. 90° SHORT SWEEPS SHALL BE USED UNDER ANTENNA ARM. CABLES MUST TRANSITION ON THE INSIDE OR BOTTOM OF ARMS. (NO CABLE SHALL BE INSTALLED ON TOP OF ARMS.)
- 6. CABLE CLAMPS SHALL BE UTILIZED TO SECURE CABLE TO
  ARMS; 2" CARRIER CABLE ID TAGS SHALL BE PLACED ON BOTH SIDES OF
- 7. UTILIZE A 90° CONNECTOR AT CABLE CONNECTION TO ANTENNA.
- 8. 1/2" CABLE TO BE UTILIZED UNLESS NOTED OTHERWISE.
- 9. VOIDS AROUND CABLES AT CONDUIT OPENINGS SHALL BE FILLED WITH FOAM SEALANT TO PREVENT WATER INTRUSION.







	DRAWN BY:		JRR	
	DATE:		06/12/2019	
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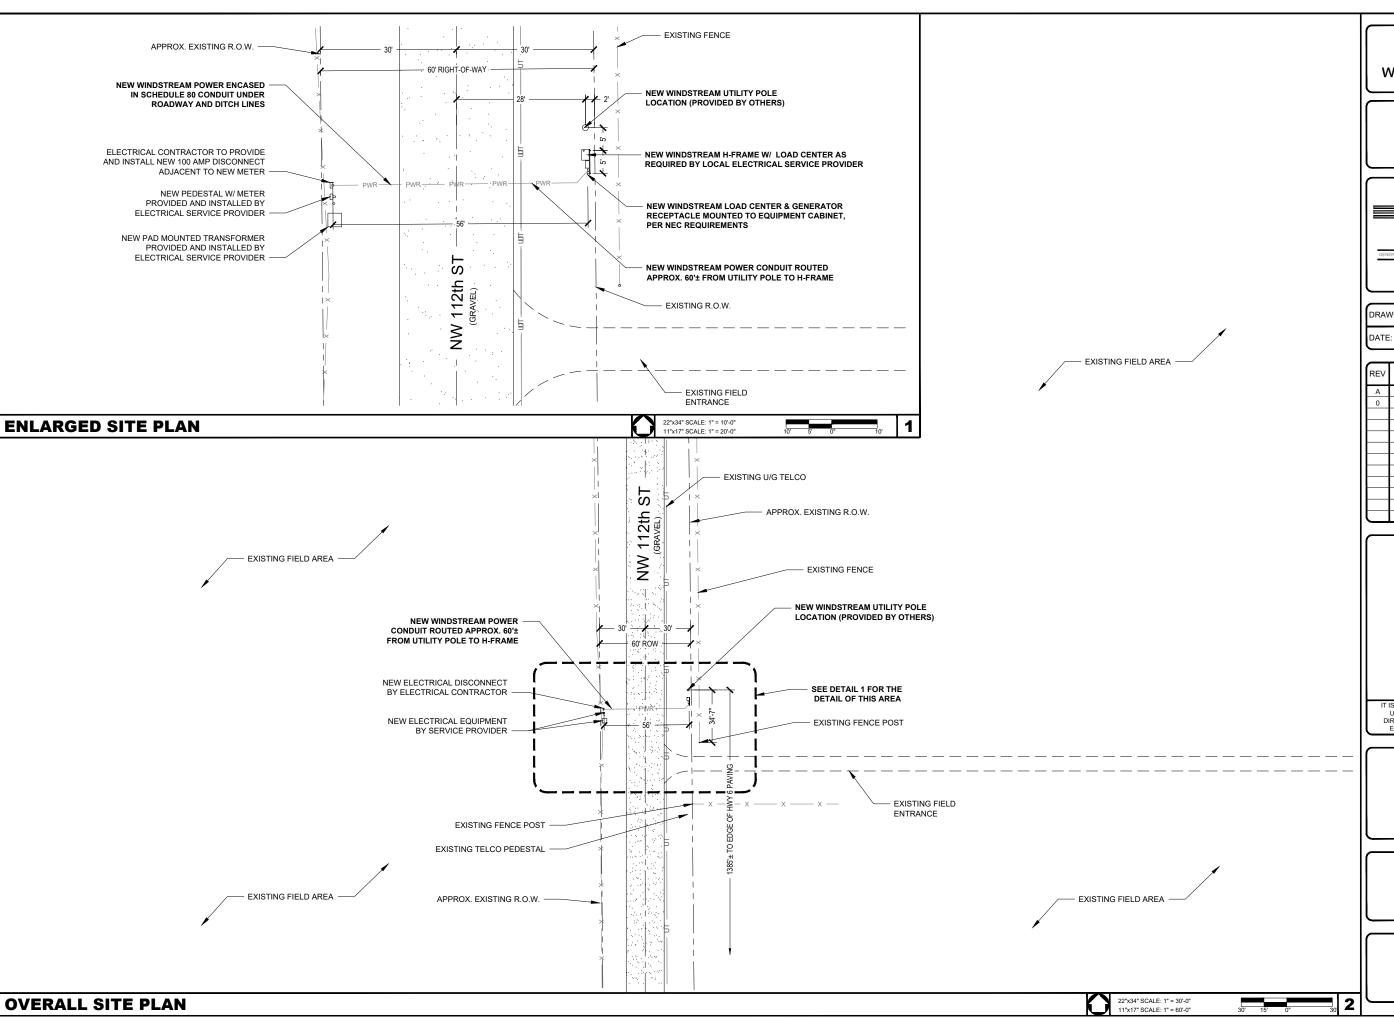
T IS A VIOLATION OF LAW FOR ANY PERSON UNLESS THEY ARE ACTING UNDER THE DIRECTION OF A LICENSED PROFESSIONAL ENGINEER, TO ALTER THIS DOCUMENT.

#### WS-LNCL-RL07

462 NW 112TH STREET LINCOLN, NE 68528 LANCASTER COUNTY

SHEET TITLE
GENERAL
NOTES

SHEET NUMBER









DRAWN BY:	JRR
DATE:	06/12/2019

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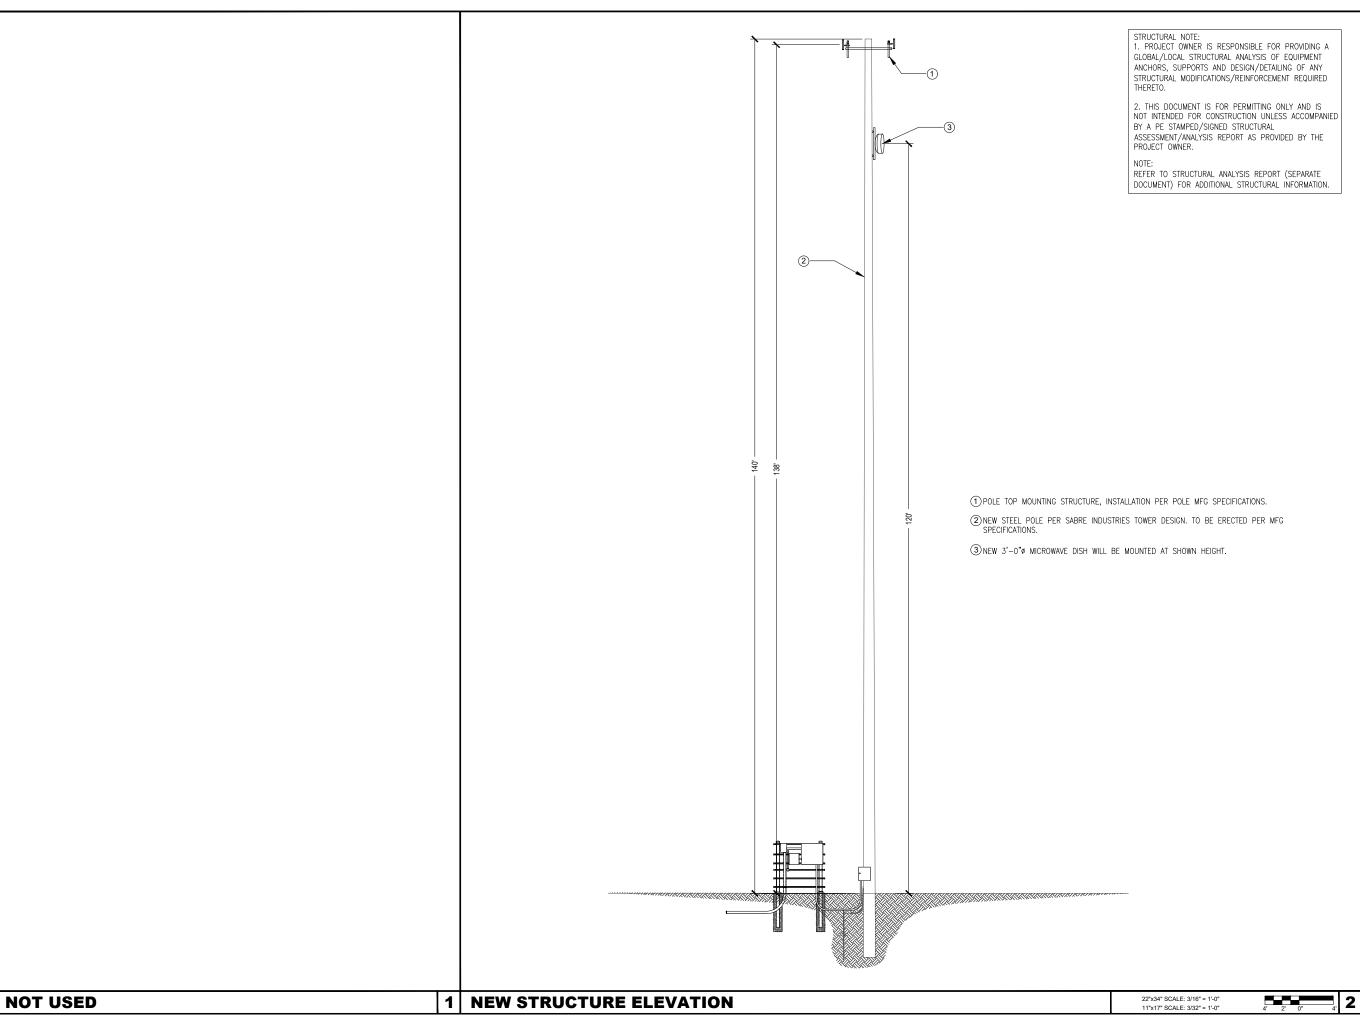
462 NW 112TH STREET LINCOLN, NE 68528 LANCASTER COUNTY

SHEET TITLE

SITE PLAN

SHEET NUMBER

**C-1** 









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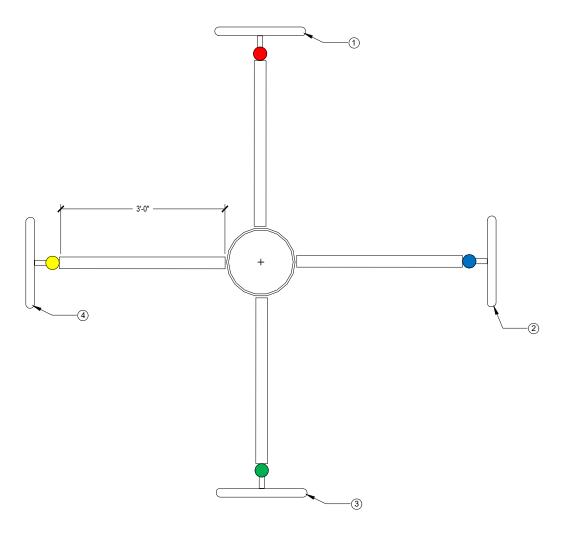
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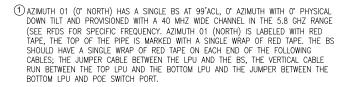
462 NW 112TH STREET LINCOLN, NE 68528 LANCASTER COUNTY

SHEET TITLE
ELEVATION
DETAILS

SHEET NUMBER

**C-2** 





- (2) AZIMUTH 02 (90' EAST) HAS A SINGLE BS AT 99'ACL, 90' AZIMUTH WITH 0' PHYSICAL DOWN TILT AND PROVISIONED WITH A 40 MHZ WIDE CHANNEL IN THE 5.8 GHZ RANGE (SEE RFDS FOR SPECIFIC FREQUENCY, AZIMUTH 02 (EAST) IS LABELED WITH BLUE TAPE, THE TOP OF THE PIPE IS MARKED WITH A SINGLE WRAP OF BLUE TAPE. THE BS SHOULD HAVE A SINGLE WRAP OF BLUE TAPE ON EACH END OF THE FOLLOWING CABLES; THE JUMPER CABLE BETWEEN THE LPU AND THE BS, THE VERTICAL CABLE RUN BETWEEN THE TOP LPU AND THE BOTTOM LPU AND THE JUMPER BETWEEN THE BOTTOM LPU AND POE SWITCH PORT.
- (3) AZIMUTH 03 (180° SOUTH) HAS A SINGLE BS AT 99'ACL, 180° AZIMUTH WITH 0° PHYSICAL DOWN TILT AND PROVISIONED WITH A 40 MHZ WIDE CHANNEL IN THE 5.8 GHZ RANGE (SEE RFDS FOR SPECIFIC FREQUENCY. AZIMUTH 04 (WEST) IS LABELED WITH GREEN TAPE, THE TOP OF THE PIPE IS MARKED WITH A SINGLE WRAP OF GREEN TAPE. THE BS SHOULD HAVE A SINGLE WRAP OF GREEN TAPE ON EACH END OF THE FOLLOWING CABLES; THE JUMPER CABLE BETWEEN THE LPU AND THE BS, THE VERTICAL CABLE RUN BETWEEN THE TOP LPU AND THE BOTTOM LPU AND THE JUMPER BETWEEN THE BOTTOM LPU AND POE SWITCH PORT.
- (4) AZIMUTH 04 (270' WEST) HAS A SINGLE BS AT 99'ACL, 270' AZIMUTH WITH 0' PHYSICAL DOWN TILT AND PROVISIONED WITH A 40 MHZ WIDE CHANNEL IN THE 5.8 GHZ RANGE (SEE RFDS FOR SPECIFIC FREQUENCY. AZIMUTH 04 (WEST) IS LABELED WITH YELLOW TAPE, THE TOP OF THE PIPE IS MARKED WITH A SINGLE WRAP OF YELLOW TAPE. THE BS SHOULD HAVE A SINGLE WRAP OF YELLOW TAPE ON EACH END OF THE FOLLOWING CABLES; THE JUMPER CABLE BETWEEN THE LPU AND THE BS, THE VERTICAL CABLE RUN BETWEEN THE TOP LPU AND THE BOTTOM LPU AND THE JUMPER BETWEEN THE BOTTOM LPU AND POE SWITCH PORT.







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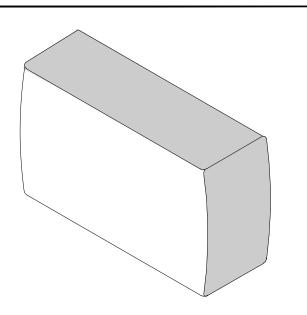
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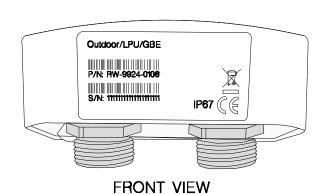
462 NW 112TH STREET LINCOLN, NE 68528 LANCASTER COUNTY

SHEET TITLE ANTENNA LAYOUT **DETAILS** 

SHEET NUMBER



	BASE STATION		
N	MANUF:	RADWIN	
F	PART #:	RW-5BG5-0649	
H	HEIGHT:	8.86"	
١	WIDTH:	14.01"	
[	DEPTH:	3.7"	
	WEIGHT:	7.28 LBS	



LIGHTNING PROTECTION			
MANUF:	RADWIN		
PART #:	RW-9924-0106		
HEIGHT:	2.04"		
WIDTH:	3.87"		
DEPTH:	1.88"		
WEIGHT:	0.49 LBS		



CABINET		
MANUF:	WESTELL	
PART #:	BXM1019-NHE3	
HEIGHT:	22.5"	
WIDTH:	25.5"	
DEPTH:	27.8"	
WEIGHT:	70.00 LBS	







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l	DATE:	06/12/2019

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#### WS-LNCL-RL07

462 NW 112TH STREET LINCOLN, NE 68528 LANCASTER COUNTY

SHEET TITLE
EQUIPMENT
DETAILS

SHEET NUMBER


**D-1** 

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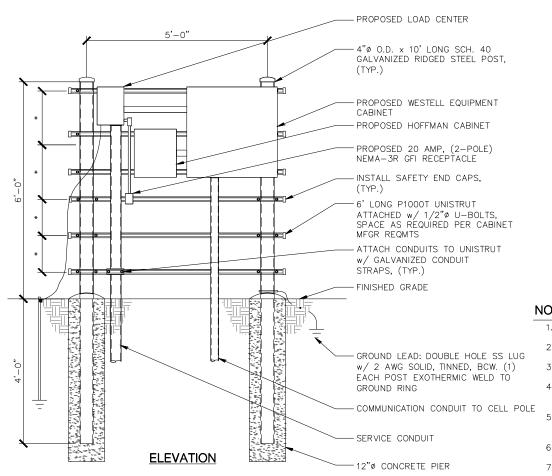
# 1 LIGHTNING PROTECTOR

H-FRAME DETAIL

# WESTELL BOXER OUTDOOR CABINET

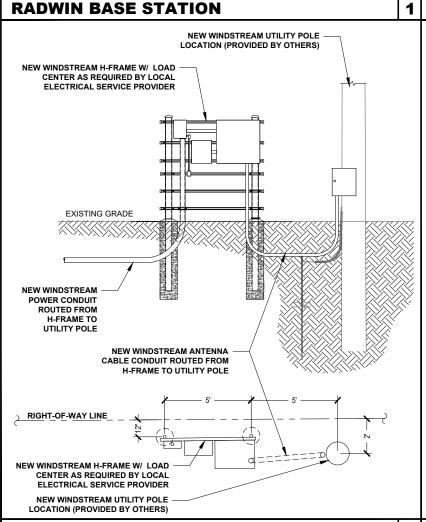



**DETAIL RACK ELEVATION** 




NOTES:

- 1. \*- COORDINATE ELEVATIONS WITH EQUIPMENT/MOUNTING HEIGHT.
- 2. STEEL SHALL BE HOT DIP GALVANIZED.
- 3. CABINETS SHALL BE MOUNTED WITH STAINLESS STEEL BOLTS.
- 4. METAL POSTS ARE NOT ALLOWED TO SERVE AS EQUIPMENT GROUNDING CONDUCTOR.
- 5. UNISTRUT SHALL NOT EXTEND BEYOND POST & MUST HAVE SAFETY END CAPS FOR SAFETY REASONS.
- 6. METALLIC PARTS SHALL BE BONDED ACCORDING TO THE NEC.
- 7. GROUNDING SHALL CONFORM TO NEC AND SECTION 436-439.

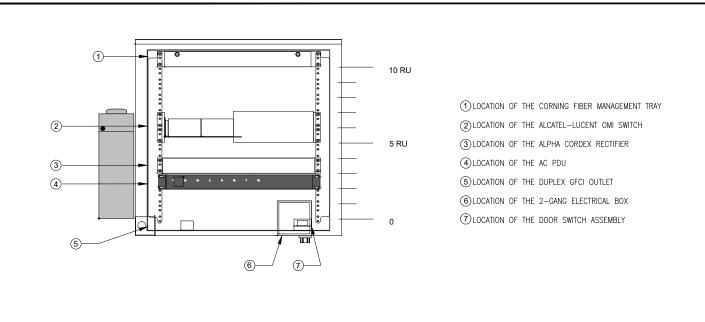

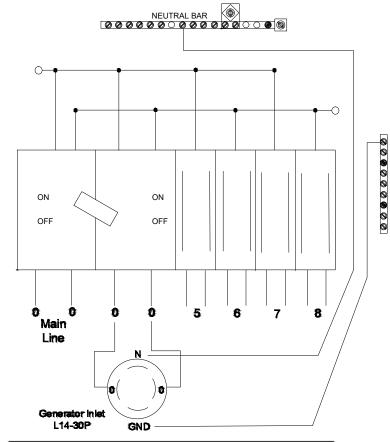

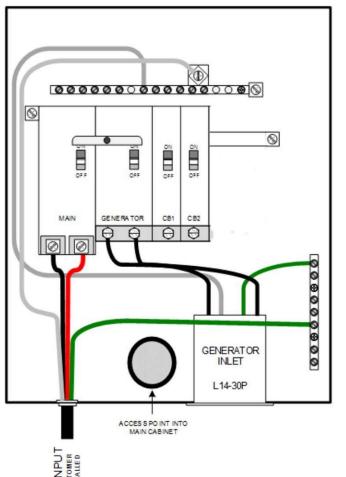







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Į	DATE:	06/12/2019

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#### WS-LNCL-RL07

462 NW 112TH STREET LINCOLN, NE 68528 LANCASTER COUNTY

SHEET TITLE **ELECTRICAL &** GROUNDING **DETAILS** 

SHEET NUMBER


**E-1** 

3

**NOT USED** 

**CABINET DETAIL** 

2 LOAD CENTER

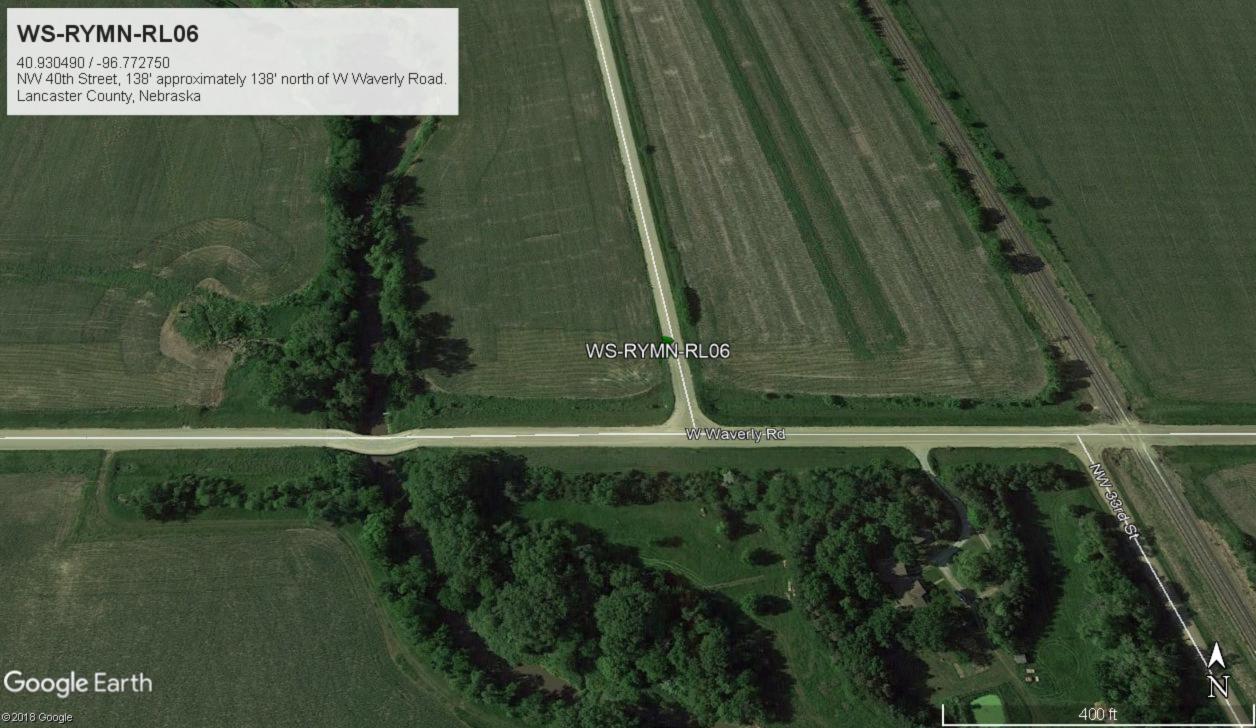

# WS-RYMN-RL06

12013 NW 40TH STREET RAYMOND, NE 68428

# SITE INFORMATION

 SITE ID:
 WS-RYMN-RL06

 ADDRESS:
 12013 NW 407H STREET

 RAYMOND, NE 68428
 COUNTY:

LATITUDE: 40.9293998\* LONGITUDE: -96.7958117\*

JURISDICTION:

# CONTACTS

PROJECT MANAGER:

WINDSTREAM

LANCASTER COUNTY

PROFESSIONAL ENGINEER: IRISH TOWER, LLC
4603 BERMUDA DRIVE
SUGAR LAND, TEXAS 77479

jacob.goralski@irishtov

PROPERTY OWNER:

# **GENERAL NOTES**

THE FACILITY IS NOT FOR HUMAN HABITATION. A TECHNICIAN WILL VISIT THE SITE AS REQUIRED FOR ROUTINE MAINTENANCE. THE PROJECT WILL NOT RESULT IN ANY SIGNIFICANT DISTURBANCE OR EFFECT ON DRAINAGE; NO SANITARY SEWER SERVICE, POTABLE WATER, OR TRASH DISPOSAL IS REQUIRED AND NO COMMERCIAL SIGNAGE IS NEW. THE SITE LOCATION IS SUBJECT TO MOVING, UP TO 10' FROM PROPOSED LOCATION, AS NEEDED TO REPE WITHIN PUBLIC ROW, AVOID EXISTING UTILITY LINES, AND AVOID EXISTING UTILITY LINES, AND AVOID LINE-OF-SIGHT OBSTRUCTIONS WITH BOTH FOOT AND AUTOMOTIVE TRAFFIC: CONTRACTOR SHALL NOTIFY ENGINEER OF RECORD PRIOR TO ANY CHANGES.



# PROJECT DESCRIPTION

THESE DRAWINGS DEPICT AN UTILITY POLE WITH ANTENNA INSTALLATION TO PROVIDE HIGH SPEED INTERNET SERVICE IN RURAL AREAS. THIS INSTALLATION SHALL CONSIST OF THE ZOMENT OF A NEW POLE, FOUR (4) ANTENNAS, ONE (1) MICROWAVE DISH AND RADIO, ONE (1) CONCEALMENT CABINET AND ASSOCIATED ELECTRICAL COMPONENTS AND MOUNTING BRACKETS AS REQUIRED

### **ENGINEERING**

ALL WORK AND MATERIALS SHALL BE PERFORMED AND INSTALLED IN ACCORDANCE WITH THE CURRENT EDITIONS OF THE FOLLOWING CODES AS ADOPTED BY THE LOCAL GOVERNING AUTHORITIES. NOTHING IN THESE PLANS IS TO BE CONSTRUCTED TO PERMIT WORK NOT CONFORMING TO THESE CODES.

2011 NATIONAL ELECTRICAL CODE
2012 INTERNATIONAL BUILDING CODE
2012 INTERNATIONAL MECHANICAL CODE
2012 INTERNATIONAL PLUMBING CODE
2012 LIFE SAFETY CODE (NFPA 101)

2012 INTERNATIONAL FIRE CODE CITY AND/OR COUNTY ORDINANCES LOCAL BUILDING CODE(S) ANSI EIA/TIA 222-G

SHEET NO:	SHEET TITLE
T-1	TITLE SHEET
T-2	GENERAL NOTES
C-1	SITE PLANS
C-2	ELEVATION DETAILS
C-3	ANTENNA LAYOUT DETAILS
D-1	EQUIPMENT DETAILS
E-1	ELECTRICAL & GROUNDING DETAILS

NOTE: DRAWINGS ARE SCALED TO 11X17

CONTRACTOR SHALL VERIFY ALL PLANS & EXISTING DIMENSIONS & CONDITIONS ON THE JOB SITE & SHALL IMMEDIATELY NOTIFY THE ARCHITECT OR ENGINEER IN WRITING OF ANY DISCREPANCIES BEFORE PROCEEDING WITH THE WORK OR BE RESPONSIBLE FOR SAME.









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#### WS-RYMN-RL06

12013 NW 40TH STREET RAYMOND, NE 68428 LANCASTER COUNTY

SHEET TITLE

TITLE SHEET

SHEET NUMBER

#### GENERAL NOTES

- 1. THE CONTRACTOR SHALL BE RESPONSIBLE FOR SURVEY MONUMENTS AND/OR VERTICAL CONTROL BENCHMARKS WHICH ARE DISTURBED OR DAMAGED BY CONSTRUCTION. A LAND SURVEYOR MUST FIELD LOCATE, REFERENCE, AND/OR PRESERVE ALL HISTORICAL OR CONTROLLING MONUMENTS PRIOR TO ANY EARTHWORK. IF DAMAGED, SUCH MONUMENTS SHALL BE REPLACED WITH APPROPRIATE MONUMENTS BY A LAND SURVEYOR. A CORNER RECORD OR RECORD OF SURVEY, AS APPROPRIATE, SHALL BE FILED AS REQUIRED BY THE PROFESSIONAL LAND SURVEYORS ACT.
- 2. IMPORTANT NOTICE: CONTRACTOR SHALL CALL LOCAL UNDERGROUND LOCATE SERVICE THREE WORKING DAYS BEFORE ANY CONSTRUCTION.
- 3. CONTRACTOR SHALL BE RESPONSIBLE FOR LOCATING ALL EXISTING UTILITIES WITHIN PROPOSED EXCAVATIONS AND MUST MAINTAIN MINIMUM VERTICAL AND HORIZONTAL CLEARANCES AS CALLED FOR BY LOCAL CODES AND/OR ORDINANCES.
- 4. CONTRACTOR IS RESPONSIBLE FOR REPAIR AND/OR REPLACEMENT OF ANY EXISTING STRUCTURES OR LANDSCAPING DAMAGED DURING CONSTRUCTION.
- 5. CONTRACTOR SHALL REPLACE OR REPAIR ALL TRAFFIC SIGNAL LOOPS, CONDUIT, AND LANE STRIPING DAMAGED DURING CONSTRUCTION.
- 6. THIS PROJECT WILL BE INSPECTED BY ENGINEERING AND FIELD ENGINEERING DIVISION.
- 7. ANY MANHOLES OR COVERS INSTALLED AS PART OF THIS PROJECT SHALL BE LABELED COMMUNICATIONS.
- 8. THE CONTRACTOR SHALL BE RESPONSIBLE FOR IMPLEMENTATION OF AN EROSION CONTROL PLAN WHICH MEETS ALL APPLICABLE REQUIREMENTS OF STATE AND LOCAL AGENCIES HAVING JURISDICTION.
- 9. THE CONTRACTOR SHALL MAINTAIN MATERIALS AND EQUIPMENT ON SITE FOR UNFORESEEN SITUATIONS INCLUDING DAMAGE TO UNDERGROUND WATER, SEWER, AND STORM DRAIN FACILITIES WHICH COULD GENERATE FLOWS ABLE TO CAUSE EROSION AND SEDIMENT POLITICION

#### SPECIAL NOTES

- 1. INDEMNIFICATION CLAUSE: THE CONTRACTOR AGREES AND SHALL: ASSUME SOLE AND COMPLETE RESPONSIBILITY OF THE JOB SITE CONDITIONS DURING THE COURSE OF CONSTRUCTION OF THIS PROJECT, INCLUDING THE SAFETY OF ALL PERSONS AND PROPERTIES. THESE REQUIREMENTS SHALL APPLY CONTINUOUSLY AND NOT BE LIMITED TO NORMAL WORKING HOURS AND CONDITIONS. THE CONTRACTOR FURTHER AGREES TO DEFEND INDEMNITY AND HOLD OWNER, REPRESENTATIVES, AND ENGINEERS HARMLESS FROM ANY AND ALL LIABILITY, REAL OR ALLEGED IN CONNECTION WITH THE PERFORMANCE OF THE WORK ON THIS PROJECT.
- 2. PRIOR TO START OF CONSTRUCTION AND THROUGH PROJECT COMPLETION, THE CONTRACTOR SHALL REMAIN IN FULL COMPLIANCE WITH CURRENT FEDERAL, STATE, AND LOCAL OCCUPATIONAL HEALTH AND SAFETY REGULATIONS.
- 3. ALL WORK SHALL CONFORM TO THE LATEST STANDARD "SPECIFICATIONS FOR PUBLIC WORKS CONSTRUCTION" AS ADOPTED BY THE CITY, COUNTY OR STATE AND AS MODIFIED BY STANDARD PLANS AND ADDENDUMS.
- 4. ALL UTILITIES AND OTHER FACILITIES DEPICTED ON THE PLANS ARE BASED ON A SEARCH OF AVAILABLE RECORDS AND FIELD OBSERVATIONS. THE CONTRACTOR SHALL VERIFY PRIOR TO CONSTRUCTION START AND USE EXTREME CARE AND PROTECTIVE MEASURES TO AVOID DAMAGE TO ANY FACILITIES WETHER OR NOT INDICATED ON THESE PLANS. THE CONTRACTOR IS RESPONSIBLE FOR THE PROTECTION OF ALL FACILITIES WITHIN THE LIMITS OF WORK, WHETHER OR NOT DEPICTED ONT THESE PLANS.
- 5. THE CONTRACTOR SHALL BE RESPONSIBLE FOR NOTIFICATION OF ANY CITY, COUNTY OR STATE ENGINEER INSPECTION DEPARTMENT A MINIMUM TWO DAYS PRIOR TO COMMENCEMENT OF ACTIVITY REQUIRING THEIR INVOLVEMENT.
- 6. THE EXPIRATION OF THE PERMIT FOR THIS PROJECT SHALL BE SPECIFIED BY THE LOCAL AUTHORITY HAVING JURISDICTION.
- 7. ALL UNDERGROUND CONDUITS PLACED AS PART OF THIS PROJECT MUST HAVE A MINIMUM COVER OF 48 INCHES UNLESS OTHERWISE APPROVED.
- 8. THE CONTRACTOR SHALL TUNNEL ALL CURB AND GUTTERS AND BORE ALL CONCRETE DRIVEWAYS AND WALKWAYS AT THE DIRECTION OF THE CITY, COUNTY OR STATE ENGINEER HAVING JURISDICTION.
- 9. ALL PAVEMENT CUT OR DAMAGED AS PART OF THIS PROJECT SHALL BE REPLACED AT THE DIRECTION OF THE CITY, COUNTY OR STATE ENGINEER HAVING JURISDICTION.
- 10. ALL SHRUBS, PLANTS OR TREES DAMAGED OR DISTURBED DURING THE COURSE OF THE WORK, SHALL BE REPLANTED AND/OR REPLACED SO AS TO RESTORE THE WORK SITE TO ITS ORIGINAL CONDITION.
- 11. THE CONTRACTOR SHALL BE RESPONSIBLE FOR PROCESSING OF ALL APPLICANT PERMIT FORMS ALONG WITH REQUIRED LIABILITY INSURANCE FORMS CLEARLY DEMONSTRATING OWNER, OWNER REPRESENTATIVES, ENGINEER, AND CITY, COUNTY OR STATE ARE ALSO INSURED WITH THE REQUIRED LIABILITY INSURANCE FOR THIS CONSTRUCTION PROJECT.
- 12. ALL SUBSURFACE STRUCTURES INCLUDING BUT NOT LIMITED TO VAULTS, PEDESTALS, AND CONDUITS SHALL BE AS SPECIFIED IN THESE PLANS OR AS SPECIFIED BY THE ENGINEER. ANY DEVIATIONS SHALL BE APPROVED BY THE ENGINEER IN WRITING PRIOR TO INSTALLATION.
- 13. THE CONTRACTOR IS RESPONSIBLE FOR VERIFICATION OF ALL EXISTING UTILITIES, INCLUDING BUT NOT LIMITED TO SEWER LATERALS AND WATER SERVICES, BOTH VERTICAL AND HORIZONTAL, PRIOR TO COMMENCING IMPROVEMENT OPERATIONS.
- 14. THE CONTRACTOR IS RESPONSIBLE FOR COMPLETION OF EXPLORATION EXCAVATIONS CONDUCTED FOR THE PURPOSE OF LOCATING EXISTING FACILITIES SUFFICIENTLY AHEAD OF CONSTRUCTION TO PERMIT REVISIONS TO PLANS AS REQUIRED.

  15. LOCATIONS OF EXISTING LITHITIES ON THESE PLANS ARE BASED LIPON EXISTING RECORD
- 15. LOCATIONS OF EXISTING UTILITIES ON THESE PLANS ARE BASED UPON EXISTING RECORDS VERIFIED WHERE POSSIBLE WITH FIELD TIES. CONTRACTOR IS RESPONSIBLE FOR VERIFICATION OF LOCATIONS SHOWN, BOTH HORIZONTAL AND VERTICALLY. PRIOR TO CONSTRUCTION, SUBSTANTIAL VARIANCES FROM THE PLANS SHALL BE COMMUNICATED TO THE ENGINEER TO FACILITATE CHANGES TO CONSTRUCTION DRAWINGS AS REQUIRED.

#### EROSION AND SEDIMENT CONTROL NOTES

TEMPORARY EROSION/SEDIMENT CONTROL PRIOR TO COMPLETION OF FINAL IMPROVEMENTS SHALL BE INSTALLED BY CONTRACTOR OR QUALIFIED PERSON AS INDICATED BELOW:

- 1. ALL REQUIREMENTS OF THE CITY, COUNTY AND STATE "STORM WATER STANDARDS" MUST BE INCORPORATED INTO THE DESIGN AND CONSTRUCTION OF THE PROPOSED GRADING/IMPROVEMENTS CONSISTENT WITH THE APPROVED STORM WATER POLLUTION PREVENTION PLAN (SWPPP), WATER QUALITY TECHNICAL REPORT (WQTR), AND/ OR WATER POLLUTION CONTROL PLAN (WPCP).
- 2. A GRAVEL BAG SILT BASIN SHALL BE INSTALLED IMMEDIATELY UPSTREAM OF STORM DRAIN INLETS AS INDICATED ON DETAILS.
- 3. FOR INLETS LOCATED AT SUMPS ADJACENT TO TOP OF SLOPES. THE CONTRACTOR SHALL INSURE WATER DRAINING TO THE SUMP IS DIRECTED INTO THE INLET AND A MINIMUM OF 1.00' FREEBOARD EXISTS AND IS MAINTAINED ABOVE THE TOP OF THE INLET. IF FREEBOARD IS NOT PROVIDED BY GRADING SHOWN ON THESE PLANS THE CONTRACTOR SHALL PROVIDE IT VIA TEMPORARY MEASURES, I.E. GRAVEL BAGS OR DIKES.
- 4. THE CONTRACTOR OR QUALIFIED PERSON SHALL BE RESPONSIBLE FOR CLEANUP OF SILT AND MUD ON ADJACENT STREET(S) AND STORM DRAIN SYSTEM DUE TO CONSTRUCTION ACTIVITY.
- 5. THE CONTRACTOR OR QUALIFIED PERSON SHALL CHECK AND MAINTAIN ALL LINED AND UNLINED DITCHES AFTER EACH RAINFALL.
- 6. THE CONTRACTOR SHALL REMOVE SILT AND DEBRIS AFTER EACH MAJOR RAINFALL.
- 7. THE CONTRACTOR SHALL MAINTAIN EQUIPMENT AND WORKERS FOR EMERGENCY WORK AT ALL TIMES DURING THE RAINY SEASON. MATERIALS NECESSARY FOR EMERGENCY MEASURES SHALL BE STOCKPILED ON SITE AT CONVENIENT LOCATIONS TO FACILITATE RAPID CONSTRUCTION OF TEMPORARY DEVICES WHEN RAIN IS IMMINENT.
- 8. THE CONTRACTOR IS RESPONSIBLE FOR RESTORING ALL EROSION/SEDIMENT CONTROL DEVICES TO WORKING ORDER TO THE SATISFACTION OF THE CITY/COUNTY/STATE ENGINEER OR RESIDENT ENGINEER FOLLOWING ANY RUN-OFF PRODUCING RAINFALL.
- 9. THE CONTRACTOR SHALL INSTALL ADDITIONAL EROSION/SEDIMENT CONTROL MEASURES AS REQUIRED BY THE RESIDENT ENGINEER DUE TO UNCOMPLETED GRADING OPERATIONS OR UNFORESEEN CIRCUMSTANCES.
- 10. THE CONTRACTOR SHALL BE RESPONSIBLE AND TAKE NECESSARY PRECAUTIONS TO PREVENT PUBLIC TRESPASS ONTO AREAS WHERE IMPOUNDED WATERS CREATE A HAZARDOUS CONDITION.
- 11. ALL EROSION/SEDIMENT CONTROL MEASURES PROVIDED PER THE APPROVED GRADING PLAN SHALL BE INCORPORATED HERON. ALL EROSION/SEDIMENT CONTROL FOR INTERIM CONDITIONS SHALL BE DONE TO THE SATISFACTION OF THE RESIDENT ENGINEER.
- 12. UPON COMPLETION OF WORK EACH DAY, GRADED AREAS AROUND THE PROJECT PERIMETER MUST DRAIN AWAY FROM THE FACE OF THE
- 13. ALL REMOVABLE PROTECTIVE DEVICES SHOWN SHALL BE IN PLACE AT THE END OF EACH WORKING DAY WHEN RAIN IS IMMINENT.
- 14. GRADING, INCLUDING CLEARING AND GRUBBING SHALL ONLY BE CONDUCTED IN AREAS WHERE THE CONTRACTOR OR QUALIFIED PERSON CAN PROVIDE EROSION/SEDIMENT CONTROL MEASURES.

#### ROW GROUND CONSTRUCTION NOTES:

- 1. THE CONTRACTOR SHALL REMOVE/CLEAN ALL DEBRIS, NAILS, STAPLES, OR NON-USED
- VERTICALS OFF THE POLE.
- 2. ALL WORK SHALL BE IN ACCORDANCE WITH MUNICIPAL, COUNTY, STATE, AND FEDERAL

#### STANDARDS AND REGULATIONS.

3. THE CONTRACTOR SHALL CALL LOCAL UNDERGROUND LOCATE SERVICE THREE WORKING DAYS

#### BEFORE ANY CONSTRUCTION IS STARTED

- 4. ALL EXISTING LANDSCAPING SHALL BE RESTORED TO ORIGINAL OR BETTER CONDITION.
- 5. ALL EQUIPMENT SHALL BE BONDED.
- 6. IF A METERING CABINET IS INSTALLED, A MINIMUM 3' CLEARANCE IS REQUIRED AT DOOR OPENING.
- 7. IF A METERING CABINET IS INSTALLED, THE CONTRACTOR SHALL CAULK THE CABINET BASE AT THE PAD.

#### STANDARD GROUNDING NOTES:

- 1. GROUND SHALL BE TESTED AT 25 OHMS OR LESS.
- 2. GROUND RODS SHALL BE 5/8"X8'. ATTACHMENT TO GROUND RODS SHALL BE EXOTHERMIC WELD OR UL LISTED DIRECT BURY CLAMP BELOW GRADF.
- 3. BURIED GROUND AND BONDING WIRE SHALL BE #6 AWG.
- 4. MOLDING SHALL BE STAPLED EVERY 1' AND AT EACH END.

#### STANDARD CONDUIT NOTES:

- 1. SCHEDULE 40 CONDUIT SHALL BE USED UNDERGROUND.
- 2. SCHEDULE 80 CONDUIT SHALL BE USED FOR RISERS.
- 3. RISERS SHALL BE ATTACHED TO POLE WITH STANDARD U-CLAMPS AND LAG SCREWS.
- 4. RISER U-CLAMPS TO BE INSTALLED EVERY 5'.
- 5. FOR U/G POWER INSTALLATIONS, 2" SDR-11 RED CONDUIT SHALL BE UTILIZED.
- 6. GROUND WIRE MOLDING STAPLES MAY BE BE UTILIZED FOR ATTACHING CONDUIT LESS THAN 1" DIAMETER.
- 7. ALL CONDUIT SHALL BE PROOFED WITH A MANDREL AND EQUIPPED WITH A PULL ROPE OR MULE TAPE.

#### STANDARD TRENCHING NOTES:

- 1. A MINIMUM OF 2'-6" OF COVER SHALL BE MAINTAINED OVER ALL ELECTRICAL CONDUITS.
- 2. A MINIMUM OF 4'-0" OF COVER SHALL BE MAINTAINED OVER ALL COMMUNICATIONS CONDUITS.
- 3. IN STREETS, SLURRY TO GRADE AND MILL DOWN 1-1/2" FOR AC CAP.
- 4. IN DIRT, SLURRY TO 18" FROM GRADE AND FILL WITH 95% COMPACTION NATIVE SOIL FOR BALANCE.
- 5. WARNING TAPE SHALL BE INSTALLED 1'-O" ABOVE ALL CONDUITS. #18 WARNING TAPE SHALL BE INSTALLED ABOVE GROUND RING.

#### ROW UTILITY POLE CONSTRUCTION NOTES:

- 1. BOLT THREADS SHALL NOT PROTRUDE MORE THAN 1-1/2".
- 2. HOLES LEFT IN POLE DUE TO REARRANGEMENT OF CLIMBERS SHALL BE FILLED.
- 3. CLIMB STEPS ADJACENT TO CONDUIT SHALL HAVE EXTENDED STEPS.
- 4. CABLE SHALL NOT IMPEDE 15" CLEAR SPACE OFF POLE FACE (12:00).
- 5. 90° SHORT SWEEPS SHALL BE USED UNDER ANTENNA ARM. CABLES MUST TRANSITION ON THE INSIDE OR BOTTOM OF ARMS. (NO CABLE SHALL BE INSTALLED ON TOP OF ARMS.)
- 6. CABLE CLAMPS SHALL BE UTILIZED TO SECURE CABLE TO
  ARMS; 2" CARRIER CABLE ID TAGS SHALL BE PLACED ON BOTH SIDES OF
  ARMS
- 7. UTILIZE A 90° CONNECTOR AT CABLE CONNECTION TO ANTENNA.
- 8. 1/2" CABLE TO BE UTILIZED UNLESS NOTED OTHERWISE.
- 9. VOIDS AROUND CABLES AT CONDUIT OPENINGS SHALL BE FILLED WITH FOAM SEALANT TO PREVENT WATER INTRUSION.







DRAWN BY:	JHR
DATE:	06/14/2019

REV	DATE	DESCRIPTION	BY
Α	06/06/2019	90% CD	JHR
0	06/14/2019	100% FINAL CD	JHR


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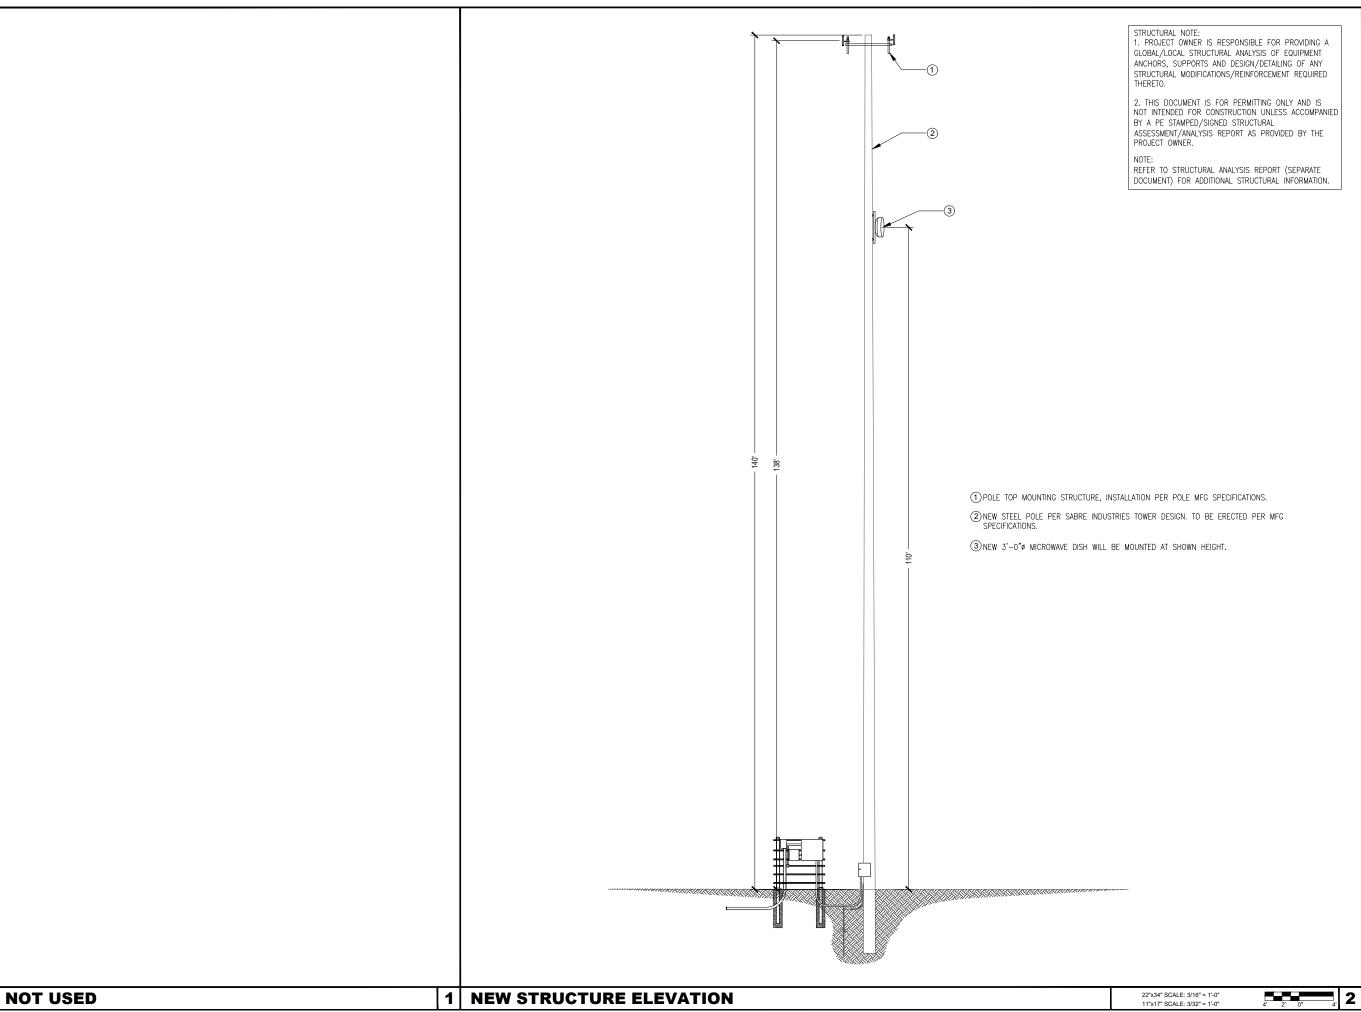
#### WS-RYMN-RL06

12013 NW 40TH STREET RAYMOND, NE 68428 LANCASTER COUNTY

SHEET TITLE
GENERAL
NOTES

SHEET NUMBER



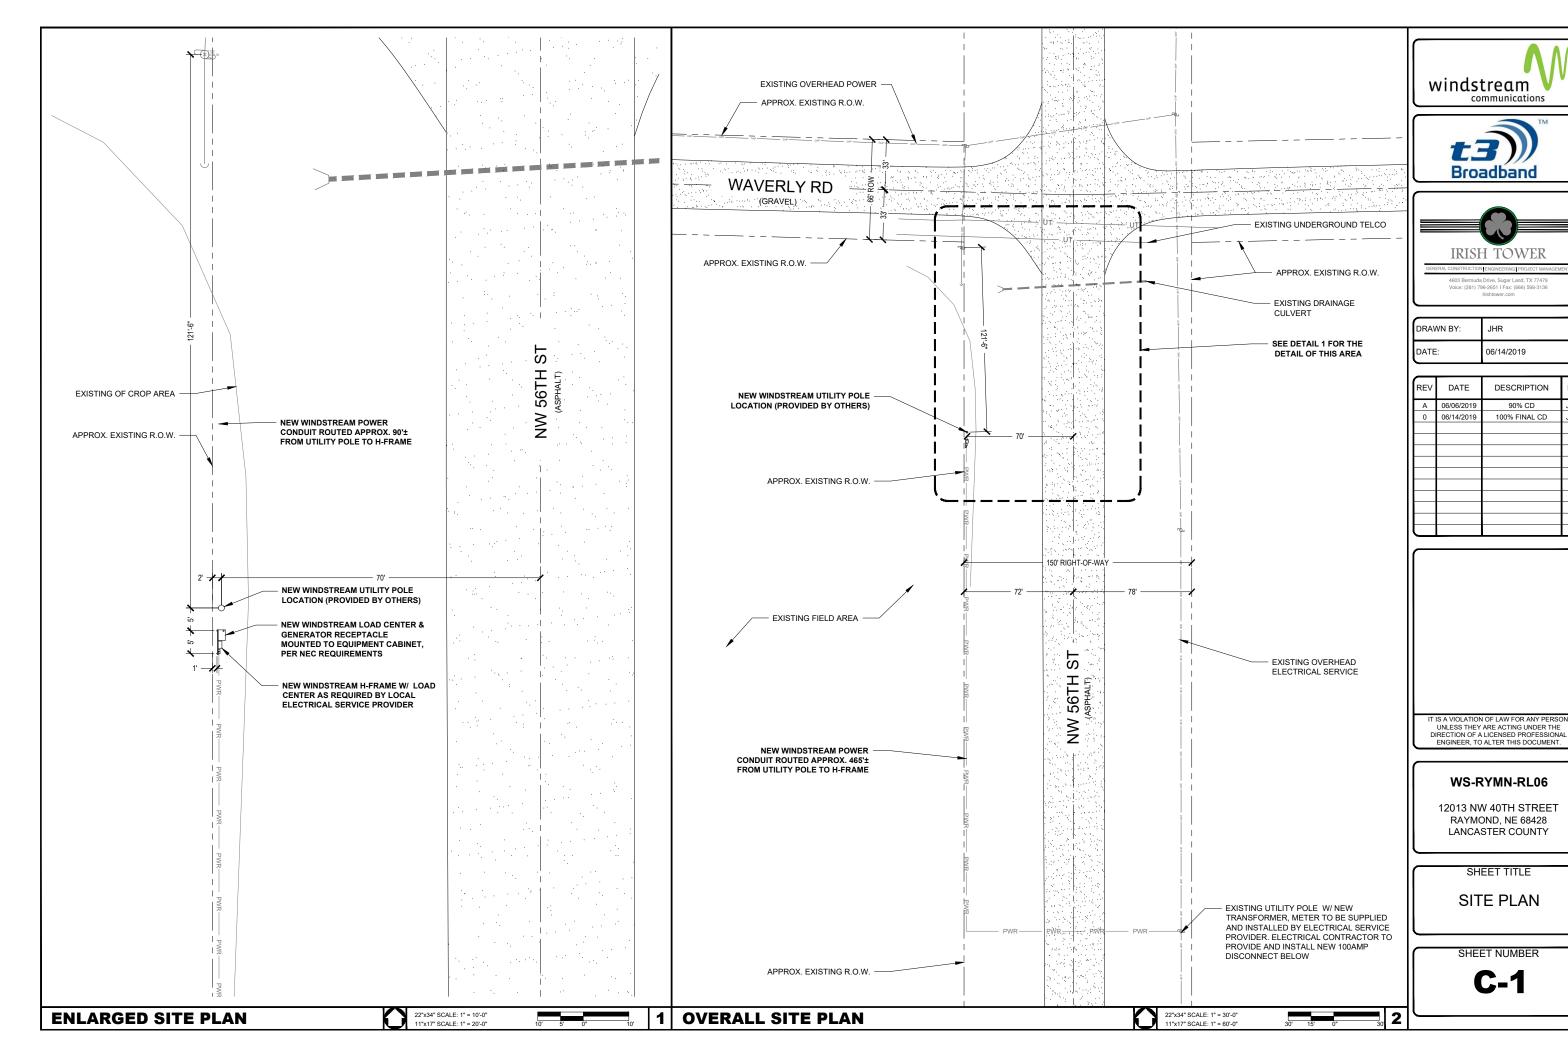







4603 Bermuda Drive, Sugar Land, TX 77479 Voice: (281) 796-2651 I Fax: (866) 598-3136 Irishtower.com

DRAWN BY:	JHR
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Α	06/06/2019	90% CD	JHR
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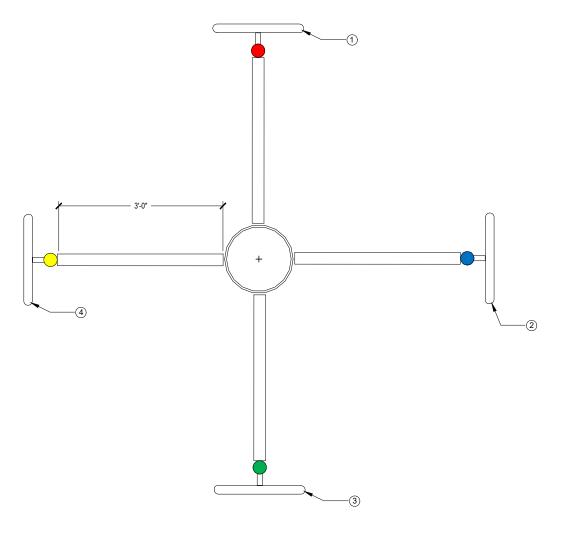
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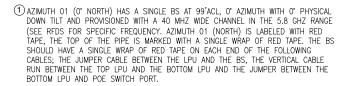
12013 NW 40TH STREET RAYMOND, NE 68428 LANCASTER COUNTY

SHEET TITLE
ELEVATION
DETAILS

SHEET NUMBER

**C-2** 





- ② AZIMUTH 02 (90° EAST) HAS A SINGLE BS AT 99°ACL, 90° AZIMUTH WITH 0° PHYSICAL DOWN TILT AND PROVISIONED WITH A 40 MHZ WIDE CHANNEL IN THE 5.8 GHZ RANGE (SEE RFDS FOR SPECIFIC FREQUENCY. AZIMUTH 02 (EAST) IS LABELED WITH BLUE TAPE, THE TOP OF THE PIPE IS MARKED WITH A SINGLE WRAP OF BLUE TAPE. THE BS SHOULD HAVE A SINGLE WRAP OF BLUE TAPE ON EACH END OF THE FOLLOWING CABLES; THE JUMPER CABLE BETWEEN THE LPU AND THE BS, THE VERTICAL CABLE RUN BETWEEN THE TOP LPU AND THE BOTTOM LPU AND THE JUMPER BETWEEN THE BOTTOM LPU AND POE SWITCH PORT.
- (3) AZIMUTH 03 (180° SOUTH) HAS A SINGLE BS AT 99°ACL, 180° AZIMUTH WITH 0° PHYSICAL DOWN TILT AND PROVISIONED WITH A 40 MHZ WIDE CHANNEL IN THE 5.8 GHZ RANGE (SEE RFDS FOR SPECIFIC FREQUENCY, AZIMUTH 04 (WEST) IS LABELED WITH GREEN TAPE, THE TOP OF THE PIPE IS MARKED WITH A SINGLE WRAP OF GREEN TAPE. THE BS SHOULD HAVE A SINGLE WRAP OF GREEN TAPE ON EACH END OF THE FOLLOWING CABLES; THE JUMPER CABLE BETWEEN THE LPU AND THE BS, THE VERTICAL CABLE RUN BETWEEN THE TOP LPU AND THE BOTTOM LPU AND THE JUMPER BETWEEN THE BOTTOM LPU AND POE SWITCH PORT.
- (4) AZIMUTH 04 (270' WEST) HAS A SINGLE BS AT 99'ACL, 270' AZIMUTH WITH 0' PHYSICAL DOWN TILT AND PROVISIONED WITH A 40 MHZ WIDE CHANNEL IN THE 5.8 GHZ RANGE (SEE RFDS FOR SPECIFIC FREQUENCY, AZIMUTH 04 (WEST) IS LABELED WITH YELLOW TAPE, THE TOP OF THE PIPE IS MARKED WITH A SINGLE WRAP OF YELLOW TAPE. THE BS SHOULD HAVE A SINGLE WRAP OF YELLOW TAPE ON EACH END OF THE FOLLOWING CABLES; THE JUMPER CABLE BETWEEN THE LPU AND THE BS, THE VERTICAL CABLE RUN BETWEEN THE TOP LPU AND THE BOTTOM LPU AND THE JUMPER BETWEEN THE BOTTOM LPU AND POE SWITCH PORT.







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DATE:	06/14/2019

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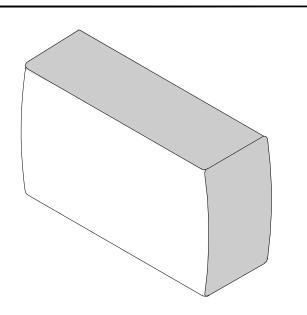
#### WS-RYMN-RL06


12013 NW 40TH STREET RAYMOND, NE 68428 LANCASTER COUNTY


SHEET TITLE
ANTENNA LAYOUT
DETAILS

SHEET NUMBER

**C**-3



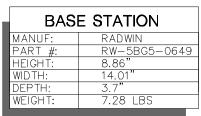

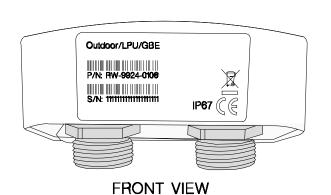

LIGHTN	ING PROTECTION
MANUF:	RADWIN
PART #:	RW-9924-0106
HEIGHT:	2.04"
WIDTH:	3.87"
DEPTH:	1.88"
WEIGHT:	0.49 LBS



С	ABINET
MANUF:	WESTELL
PART #:	BXM1019-NHE3
HEIGHT:	22.5"
WIDTH:	25.5"
DEPTH:	27.8"
WEIGHT:	70.00 LBS

# windstream





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#### WS-RYMN-RL06

12013 NW 40TH STREET RAYMOND, NE 68428 LANCASTER COUNTY

SHEET TITLE
EQUIPMENT
DETAILS

SHEET NUMBER


**D-1** 


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# 1 LIGHTNING PROTECTOR

H-FRAME DETAIL


# WESTELL BOXER OUTDOOR CABINET



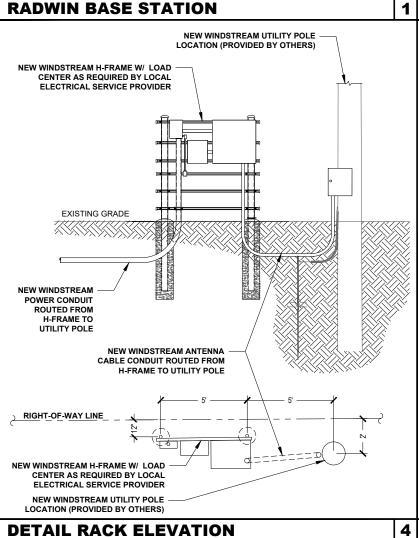


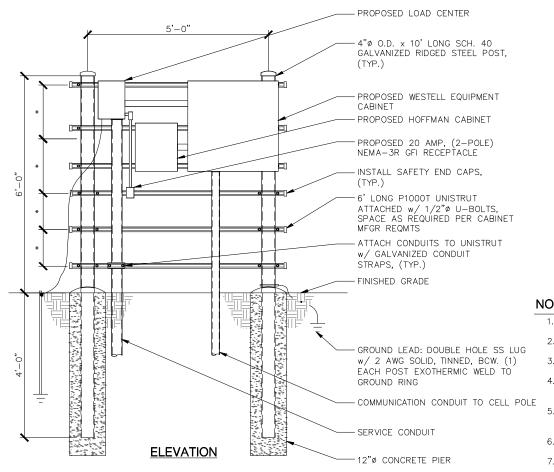
# NOTES:

- 1. \*- COORDINATE ELEVATIONS WITH EQUIPMENT/MOUNTING HEIGHT.
- 2. STEEL SHALL BE HOT DIP GALVANIZED.
- 3. CABINETS SHALL BE MOUNTED WITH STAINLESS STEEL BOLTS.
- 4. METAL POSTS ARE NOT ALLOWED TO SERVE AS EQUIPMENT GROUNDING CONDUCTOR.
- 5. UNISTRUT SHALL NOT EXTEND BEYOND POST & MUST HAVE SAFETY END CAPS FOR SAFETY REASONS.
- 6. METALLIC PARTS SHALL BE BONDED ACCORDING TO THE NEC.
- 7. GROUNDING SHALL CONFORM TO NEC AND SECTION 436-439.

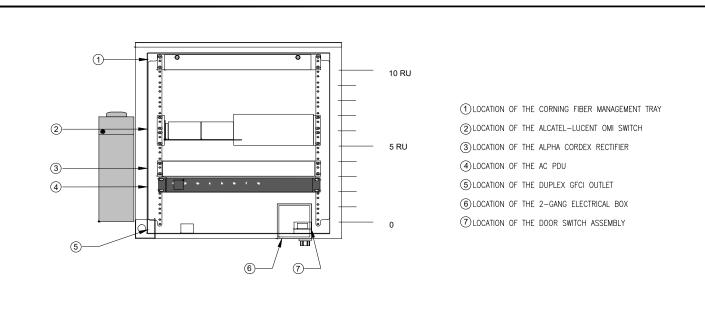

CABINET DETAIL 1

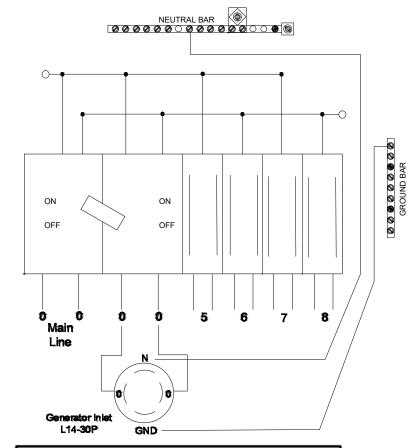

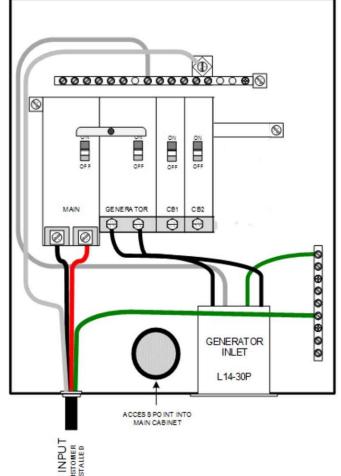







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#### WS-RYMN-RL06


12013 NW 40TH STREET RAYMOND, NE 68428 LANCASTER COUNTY

SHEET TITLE
ELECTRICAL &
GROUNDING
DETAILS

SHEET NUMBER

**E-1** 

NOT USED 2 LOAD CENTER 3

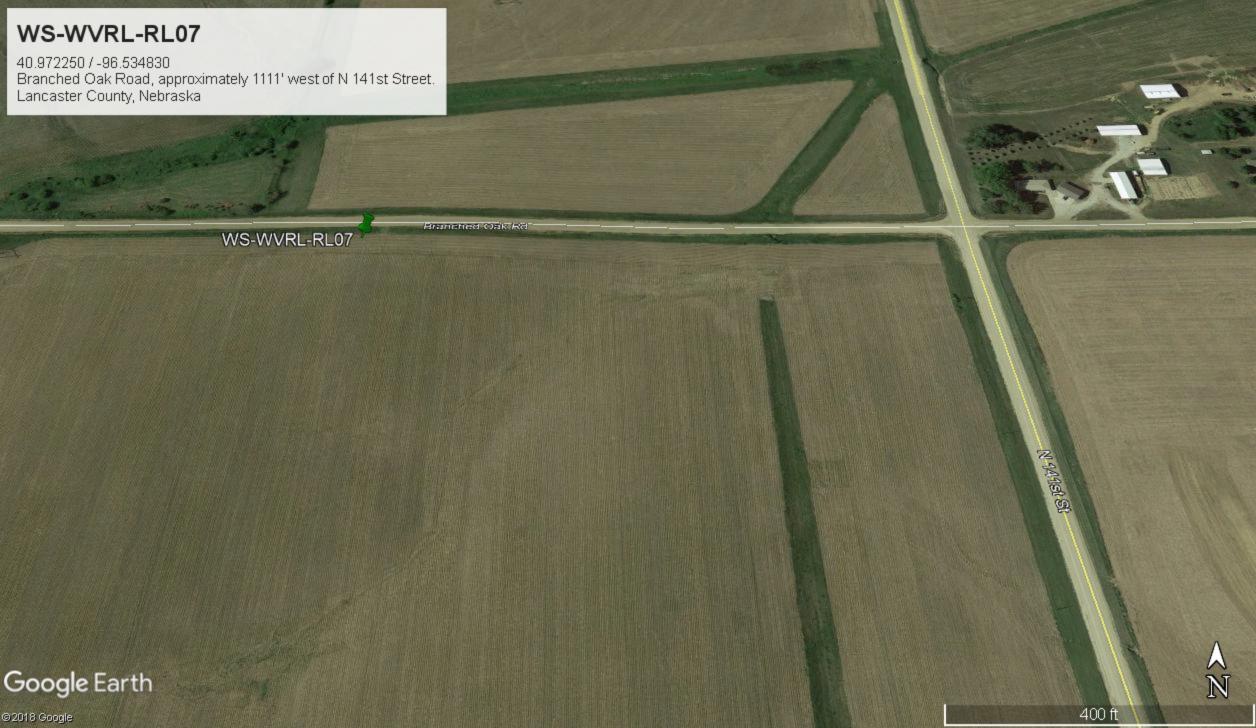

# WS-WVRL-RL07

13803 BRANCHED OAK ROAD WAVERLY, NE 68462

# SITE INFORMATION

SITE ID: WS-WVRL-RL07

ADDRESS: 13803 BRANCHED OAK ROAD WAVERLY, NE 68462

COUNTY: LANCASTER COUNTY

LATITUDE: 40.97225 LONGITUDE: -96.5348

JURISDICTION:

#### **CONTACTS**

LANCASTER COUNTY

PROJECT MANAGER: W


PROFESSIONAL ENGINEER: IRISH TOWER, LLC 4603 BERMUDA DR

4603 BERMUDA DRIVE SUGAR LAND, TEXAS 77479

PROPERTY OWNER:

### **GENERAL NOTES**

THE FACILITY IS NOT FOR HUMAN HABITATION. A TECHNICIAN WILL VISIT THE SITE AS REQUIRED FOR ROUTINE MAINTENANCE: THE PROJECT WILL NOT RESULT IN ANY SIGNIFICANT DISTURBANCE OR EFFECT ON DRAINAGE; NO SANITARY SEWER SERVICE, POTABLE WATER, OR TRASH DISPOSAL IS REQUIRED AND NO COMMERCIAL SIGNAGE IS NEW. THE SITE LOCATION IS SUBJECT TO MOVING, UP TO 10' FROM POPOOSED LOCATION, AS NEEDED TO KEEP WITHIN PUBLIC ROW, AVOID EXISTING UTILITY LINES, AND AVOID LINE-OF-SIGHT OBSTRUCTIONS WITH BOTH FOOT AND AUTOMOTIVE TRAFFIC: CONTRACTOR SHALL NOTIFY ENGINEER OF RECORD PRIOR TO ANY CHANGES.

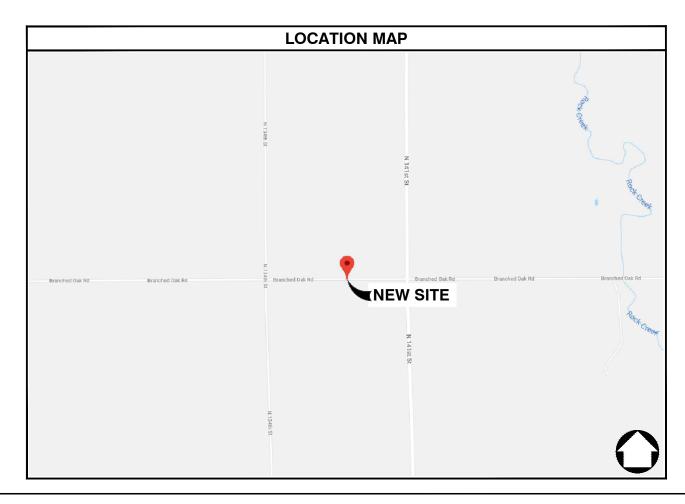

#### PROJECT DESCRIPTION

THESE DRAWINGS DEPICT AN UTILITY POLE WITH ANTENNA INSTALLATION TO PROVIDE HIGH SPEED INTERNET SERVICE IN RURAL AREAS. THIS INSTALLATION SHALL CONSIST OF THE PLACEMENT OF A NEW POLE, FOUR (4) ANTENNAS, ONE (1) MICROWAVE DISH, ONE (1) CONCEALMENT CABINET AND ASSOCIATED ELECTRICAL COMPONENTS AND MOUNTING BRACKETS AS REQUIRED

### **ENGINEERING**

ALL WORK AND MATERIALS SHALL BE PERFORMED AND INSTALLED IN ACCORDANCE WITH THE CURRENT EDITIONS OF THE FOLLOWING CODES AS ADOPTED BY THE LOCAL GOVERNING AUTHORITIES. NOTHING IN THESE PLANS IS TO BE CONSTRUCTED TO PERMIT WORK NOT CONFORMING TO THESE CODES.

2011 NATIONAL ELECTRICAL CODE
2012 INTERNATIONAL BUILDING CODE
2012 INTERNATIONAL MECHANICAL CODE
2012 INTERNATIONAL PLUMBING CODE
2012 INTERNATIONAL PLUMBING CODE
2012 LIFE SAFETY CODE (NFPA 101)

SHEET NO:	SHEET TITLE
T-1	TITLE SHEET
T-2	GENERAL NOTES
C-1	SITE PLANS
C-2	ELEVATION DETAILS
C-3	ANTENNA LAYOUT DETAILS
C-4	STRUCTURE DETAILS
D-1	EQUIPMENT DETAILS
E-1	ELECTRICAL & GROUNDING DETAILS

CONTRACTOR SHALL VERIFY ALL PLANS & EXISTING DIMENSIONS & CONDITIONS ON THE JOB SITE & SHALL IMMEDIATELY NOTIFY THE ARCHITECT OR ENGINEER IN WRITING OF ANY DISCREPANCIES BEFORE PROCEEDING WITH THE WORK OR BE RESPONSIBLE FOR SAME.









ĺ	DRAWN BY:	JRR
	DATE:	06/05/2019

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#### WS-WVRL-RL07

13803 BRANCHED OAK ROAD WAVERLY, NE 68462 LANCASTER COUNTY

SHEET TITLE

TITLE SHEET

SHEET NUMBER

#### GENERAL NOTES

- 1. THE CONTRACTOR SHALL BE RESPONSIBLE FOR SURVEY MONUMENTS AND/OR VERTICAL CONTROL BENCHMARKS WHICH ARE DISTURBED OR DAMAGED BY CONSTRUCTION. A LAND SURVEYOR MUST FIELD LOCATE, REFERENCE, AND/OR PRESERVE ALL HISTORICAL OR CONTROLLING MONUMENTS PRIOR TO ANY EARTHWORK. IF DAMAGED, SUCH MONUMENTS SHALL BE REPLACED WITH APPROPRIATE MONUMENTS BY A LAND SURVEYOR. A CORNER RECORD OR RECORD OF SURVEY, AS APPROPRIATE, SHALL BE FILED AS REQUIRED BY THE PROFESSIONAL LAND SURVEYORS ACT.
- 2. IMPORTANT NOTICE: CONTRACTOR SHALL CALL LOCAL UNDERGROUND LOCATE SERVICE THREE WORKING DAYS BEFORE ANY CONSTRUCTION.
- 3. CONTRACTOR SHALL BE RESPONSIBLE FOR LOCATING ALL EXISTING UTILITIES WITHIN PROPOSED EXCAVATIONS AND MUST MAINTAIN MINIMUM VERTICAL AND HORIZONTAL CLEARANCES AS CALLED FOR BY LOCAL CODES AND/OR ORDINANCES.
- 4. CONTRACTOR IS RESPONSIBLE FOR REPAIR AND/OR REPLACEMENT OF ANY EXISTING STRUCTURES OR LANDSCAPING DAMAGED DURING CONSTRUCTION.
- 5. CONTRACTOR SHALL REPLACE OR REPAIR ALL TRAFFIC SIGNAL LOOPS, CONDUIT, AND LANE STRIPING DAMAGED DURING CONSTRUCTION.
- 6. THIS PROJECT WILL BE INSPECTED BY ENGINEERING AND FIELD ENGINEERING DIVISION.
- 7. ANY MANHOLES OR COVERS INSTALLED AS PART OF THIS PROJECT SHALL BE LABELED COMMUNICATIONS.
- 8. THE CONTRACTOR SHALL BE RESPONSIBLE FOR IMPLEMENTATION OF AN EROSION CONTROL PLAN WHICH MEETS ALL APPLICABLE REQUIREMENTS OF STATE AND LOCAL AGENCIES HAVING JURISDICTION.
- 9. THE CONTRACTOR SHALL MAINTAIN MATERIALS AND EQUIPMENT ON SITE FOR UNFORESEEN SITUATIONS INCLUDING DAMAGE TO UNDERGROUND WATER, SEWER, AND STORM DRAIN FACILITIES WHICH COULD GENERATE FLOWS ABLE TO CAUSE EROSION AND SEDIMENT POLITICIAN

#### SPECIAL NOTES

- 1. INDEMNIFICATION CLAUSE: THE CONTRACTOR AGREES AND SHALL: ASSUME SOLE AND COMPLETE RESPONSIBILITY OF THE JOB SITE CONDITIONS DURING THE COURSE OF CONSTRUCTION OF THIS PROJECT, INCLUDING THE SAFETY OF ALL PERSONS AND PROPERTIES. THESE REQUIREMENTS SHALL APPLY CONTINUOUSLY AND NOT BE LIMITED TO NORMAL WORKING HOURS AND CONDITIONS. THE CONTRACTOR FURTHER AGREES TO DEFEND INDEMNITY AND HOLD OWNER, REPRESENTATIVES, AND ENGINEERS HARMLESS FROM ANY AND ALL LIABILITY, REAL OR ALLEGED IN CONNECTION WITH THE PERFORMANCE OF THE WORK ON THIS PROJECT.
- 2. PRIOR TO START OF CONSTRUCTION AND THROUGH PROJECT COMPLETION, THE CONTRACTOR SHALL REMAIN IN FULL COMPLIANCE WITH CURRENT FEDERAL, STATE, AND LOCAL OCCUPATIONAL HEALTH AND SAFETY REGULATIONS.
- 3. ALL WORK SHALL CONFORM TO THE LATEST STANDARD "SPECIFICATIONS FOR PUBLIC WORKS CONSTRUCTION" AS ADOPTED BY THE CITY, COUNTY OR STATE AND AS MODIFIED BY STANDARD PLANS AND ADDENDLINS.
- 4. ALL UTILITIES AND OTHER FACILITIES DEPICTED ON THE PLANS ARE BASED ON A SEARCH OF AVAILABLE RECORDS AND FIELD OBSERVATIONS. THE CONTRACTOR SHALL VERIFY PRIOR TO CONSTRUCTION START AND USE EXTREME CARE AND PROTECTIVE MEASURES TO AVOID DAMAGE TO ANY FACILITIES WETHER OR NOT INDICATED ON THESE PLANS. THE CONTRACTOR IS RESPONSIBLE FOR THE PROTECTION OF ALL FACILITIES WITHIN THE LIMITS OF WORK, WHETHER OR NOT DEPICTED ONT THESE PLANS.
- 5. THE CONTRACTOR SHALL BE RESPONSIBLE FOR NOTIFICATION OF ANY CITY, COUNTY OR STATE ENGINEER INSPECTION DEPARTMENT A MINIMUM TWO DAYS PRIOR TO COMMENCEMENT OF ACTIVITY REQUIRING THEIR INVOLVEMENT.
- 6. THE EXPIRATION OF THE PERMIT FOR THIS PROJECT SHALL BE SPECIFIED BY THE LOCAL AUTHORITY HAVING JURISDICTION.
- 7. ALL UNDERGROUND CONDUITS PLACED AS PART OF THIS PROJECT MUST HAVE A MINIMUM COVER OF 48 INCHES UNLESS OTHERWISE APPROVED.
- 8. THE CONTRACTOR SHALL TUNNEL ALL CURB AND GUTTERS AND BORE ALL CONCRETE DRIVEWAYS AND WALKWAYS AT THE DIRECTION OF THE CITY, COUNTY OR STATE ENGINEER HAVING JURISDICTION.
- 9. ALL PAVEMENT CUT OR DAMAGED AS PART OF THIS PROJECT SHALL BE REPLACED AT THE DIRECTION OF THE CITY, COUNTY OR STATE ENGINEER HAVING JURISDICTION.
- 10. ALL SHRUBS, PLANTS OR TREES DAMAGED OR DISTURBED DURING THE COURSE OF THE WORK, SHALL BE REPLANTED AND/OR REPLACED SO AS TO RESTORE THE WORK SITE TO ITS ORIGINAL CONDITION.
- 11. THE CONTRACTOR SHALL BE RESPONSIBLE FOR PROCESSING OF ALL APPLICANT PERMIT FORMS ALONG WITH REQUIRED LIABILITY INSURANCE FORMS CLEARLY DEMONSTRATING OWNER, OWNER REPRESENTATIVES, ENGINEER, AND CITY, COUNTY OR STATE ARE ALSO INSURED WITH THE REQUIRED LIABILITY INSURANCE FOR THIS CONSTRUCTION PROJECT.
- 12. ALL SUBSURFACE STRUCTURES INCLUDING BUT NOT LIMITED TO VAULTS, PEDESTALS, AND CONDUITS SHALL BE AS SPECIFIED IN THESE PLANS OR AS SPECIFIED BY THE ENGINEER. ANY DEVIATIONS SHALL BE APPROVED BY THE ENGINEER IN WRITING PRIOR TO INSTALLATION.
- 13. THE CONTRACTOR IS RESPONSIBLE FOR VERIFICATION OF ALL EXISTING UTILITIES, INCLUDING BUT NOT LIMITED TO SEWER LATERALS AND WATER SERVICES, BOTH VERTICAL AND HORIZONTAL, PRIOR TO COMMENCING IMPROVEMENT OPERATIONS.
- 14. THE CONTRACTOR IS RESPONSIBLE FOR COMPLETION OF EXPLORATION EXCAVATIONS CONDUCTED FOR THE PURPOSE OF LOCATING EXISTING FACILITIES SUFFICIENTLY AHEAD OF CONSTRUCTION TO PERMIT REVISIONS TO PLANS AS REQUIRED.
- 15. LOCATIONS OF EXISTING UTILITIES ON THESE PLANS ARE BASED UPON EXISTING RECORDS VERIFIED WHERE POSSIBLE WITH FIELD TIES. CONTRACTOR IS RESPONSIBLE FOR VERIFICATION OF LOCATIONS SHOWN, BOTH HORIZONTAL AND VERTICALLY. PRIOR TO CONSTRUCTION, SUBSTANTIAL VARIANCES FROM THE PLANS SHALL BE COMMUNICATED TO THE ENGINEER TO FACILITATE CHANGES TO CONSTRUCTION DRAWINGS AS REQUIRED.

#### EROSION AND SEDIMENT CONTROL NOTES

TEMPORARY EROSION/SEDIMENT CONTROL PRIOR TO COMPLETION OF FINAL IMPROVEMENTS SHALL BE INSTALLED BY CONTRACTOR OR QUALIFIED PERSON AS INDICATED BELOW:

- 1. ALL REQUIREMENTS OF THE CITY, COUNTY AND STATE "STORM WATER STANDARDS" MUST BE INCORPORATED INTO THE DESIGN AND CONSTRUCTION OF THE PROPOSED GRADING/IMPROVEMENTS CONSISTENT WITH THE APPROVED STORM WATER POLLUTION PREVENTION PLAN (SWPPP), WATER QUALITY TECHNICAL REPORT (WQTR), AND/ OR WATER POLLUTION CONTROL PLAN (WPCP).
- 2. A GRAVEL BAG SILT BASIN SHALL BE INSTALLED IMMEDIATELY UPSTREAM OF STORM DRAIN INLETS AS INDICATED ON DETAILS.
- 3. FOR INLETS LOCATED AT SUMPS ADJACENT TO TOP OF SLOPES. THE CONTRACTOR SHALL INSURE WATER DRAINING TO THE SUMP IS DIRECTED INTO THE INLET AND A MINIMUM OF 1.00' FREEBOARD EXISTS AND IS MAINTAINED ABOVE THE TOP OF THE INLET. IF FREEBOARD IS NOT PROVIDED BY GRADING SHOWN ON THESE PLANS THE CONTRACTOR SHALL PROVIDE IT VIA TEMPORARY MEASURES, I.E. GRAVEL BAGS OR DIKES.
- 4. THE CONTRACTOR OR QUALIFIED PERSON SHALL BE RESPONSIBLE FOR CLEANUP OF SILT AND MUD ON ADJACENT STREET(S) AND STORM DRAIN SYSTEM DUE TO CONSTRUCTION ACTIVITY.
- 5. THE CONTRACTOR OR QUALIFIED PERSON SHALL CHECK AND MAINTAIN ALL LINED AND UNLINED DITCHES AFTER EACH RAINFALL.
- 6. THE CONTRACTOR SHALL REMOVE SILT AND DEBRIS AFTER EACH MAJOR RAINFALL.
- 7. THE CONTRACTOR SHALL MAINTAIN EQUIPMENT AND WORKERS FOR EMERGENCY WORK AT ALL TIMES DURING THE RAINY SEASON. MATERIALS NECESSARY FOR EMERGENCY MEASURES SHALL BE STOCKPILED ON SITE AT CONVENIENT LOCATIONS TO FACILITATE RAPID CONSTRUCTION OF TEMPORARY DEVICES WHEN RAIN IS IMMINENT.
- 8. THE CONTRACTOR IS RESPONSIBLE FOR RESTORING ALL EROSION/SEDIMENT CONTROL DEVICES TO WORKING ORDER TO THE SATISFACTION OF THE CITY/COUNTY/STATE ENGINEER OR RESIDENT ENGINEER FOLLOWING ANY RUN-OFF PRODUCING RAINFALL.
- 9. THE CONTRACTOR SHALL INSTALL ADDITIONAL EROSION/SEDIMENT CONTROL MEASURES AS REQUIRED BY THE RESIDENT ENGINEER DUE TO UNCOMPLETED GRADING OPERATIONS OR UNFORESEEN CIRCUMSTANCES.
- 10. THE CONTRACTOR SHALL BE RESPONSIBLE AND TAKE NECESSARY PRECAUTIONS TO PREVENT PUBLIC TRESPASS ONTO AREAS WHERE IMPOUNDED WATERS CREATE A HAZARDOUS CONDITION.
- 11. ALL EROSION/SEDIMENT CONTROL MEASURES PROVIDED PER THE APPROVED GRADING PLAN SHALL BE INCORPORATED HERON. ALL EROSION/SEDIMENT CONTROL FOR INTERIM CONDITIONS SHALL BE DONE TO THE SATISFACTION OF THE RESIDENT ENGINEER.
- 12. UPON COMPLETION OF WORK EACH DAY, GRADED AREAS AROUND THE PROJECT PERIMETER MUST DRAIN AWAY FROM THE FACE OF THE SLOPE.
- 13. ALL REMOVABLE PROTECTIVE DEVICES SHOWN SHALL BE IN PLACE AT THE END OF EACH WORKING DAY WHEN RAIN IS IMMINENT.
- 14. GRADING, INCLUDING CLEARING AND GRUBBING SHALL ONLY BE CONDUCTED IN AREAS WHERE THE CONTRACTOR OR QUALIFIED PERSON CAN PROVIDE EROSION/SEDIMENT CONTROL MEASURES.

#### ROW GROUND CONSTRUCTION NOTES:

- 1. THE CONTRACTOR SHALL REMOVE/CLEAN ALL DEBRIS, NAILS, STAPLES, OR NON-USED
- VERTICALS OFF THE POLE.
- 2. ALL WORK SHALL BE IN ACCORDANCE WITH MUNICIPAL, COUNTY, STATE, AND FEDERAL

#### STANDARDS AND REGULATIONS.

3. THE CONTRACTOR SHALL CALL LOCAL UNDERGROUND LOCATE SERVICE THREE WORKING DAYS

#### BEFORE ANY CONSTRUCTION IS STARTED

- 4. ALL EXISTING LANDSCAPING SHALL BE RESTORED TO ORIGINAL OR BETTER CONDITION.
- 5. ALL EQUIPMENT SHALL BE BONDED.
- 6. IF A METERING CABINET IS INSTALLED, A MINIMUM 3' CLEARANCE IS REQUIRED AT DOOR OPENING.
- 7. IF A METERING CABINET IS INSTALLED, THE CONTRACTOR SHALL CAULK THE CABINET BASE AT THE PAD.

#### STANDARD GROUNDING NOTES:

- 1. GROUND SHALL BE TESTED AT 25 OHMS OR LESS.
- 2. GROUND RODS SHALL BE 5/8"X8'. ATTACHMENT TO GROUND RODS SHALL BE EXOTHERMIC WELD OR UL LISTED DIRECT BURY CLAMP BELOW GRADF.
- 3. BURIED GROUND AND BONDING WIRE SHALL BE #6 AWG.
- 4. MOLDING SHALL BE STAPLED EVERY 1' AND AT EACH END.

#### STANDARD CONDUIT NOTES:

- 1. SCHEDULE 40 CONDUIT SHALL BE USED UNDERGROUND.
- 2. SCHEDULE 80 CONDUIT SHALL BE USED FOR RISERS.
- 3. RISERS SHALL BE ATTACHED TO POLE WITH STANDARD U-CLAMPS AND LAG SCREWS.
- 4. RISER U-CLAMPS TO BE INSTALLED EVERY 5'.
- 5. FOR U/G POWER INSTALLATIONS, 2" SDR-11 RED CONDUIT SHALL BE UTILIZED.
- 6. GROUND WIRE MOLDING STAPLES MAY BE BE UTILIZED FOR ATTACHING CONDUIT LESS THAN 1" DIAMETER.
- 7. ALL CONDUIT SHALL BE PROOFED WITH A MANDREL AND EQUIPPED WITH A PULL ROPE OR MULE TAPE.

#### STANDARD TRENCHING NOTES:

- 1. A MINIMUM OF 2'-6" OF COVER SHALL BE MAINTAINED OVER ALL ELECTRICAL CONDUITS.
- 2. A MINIMUM OF 4'-0" OF COVER SHALL BE MAINTAINED OVER ALL COMMUNICATIONS CONDUITS.
- 3. IN STREETS, SLURRY TO GRADE AND MILL DOWN 1-1/2" FOR AC CAP.
- 4. IN DIRT, SLURRY TO 18" FROM GRADE AND FILL WITH 95% COMPACTION NATIVE SOIL FOR BALANCE.
- 5. WARNING TAPE SHALL BE INSTALLED 1'-O" ABOVE ALL CONDUITS. #18 WARNING TAPE SHALL BE INSTALLED ABOVE GROUND RING.

#### ROW UTILITY POLE CONSTRUCTION NOTES:

- 1. BOLT THREADS SHALL NOT PROTRUDE MORE THAN 1-1/2".
- 2. HOLES LEFT IN POLE DUE TO REARRANGEMENT OF CLIMBERS SHALL BE FILLED.
- 3. CLIMB STEPS ADJACENT TO CONDUIT SHALL HAVE EXTENDED STEPS.
- 4. CABLE SHALL NOT IMPEDE 15" CLEAR SPACE OFF POLE FACE (12:00).
- 5. 90° SHORT SWEEPS SHALL BE USED UNDER ANTENNA ARM. CABLES MUST TRANSITION ON THE INSIDE OR BOTTOM OF ARMS. (NO CABLE SHALL BE INSTALLED ON TOP OF ARMS.)
- 6. CABLE CLAMPS SHALL BE UTILIZED TO SECURE CABLE TO
  ARMS; 2" CARRIER CABLE ID TAGS SHALL BE PLACED ON BOTH SIDES OF
  ARMS
- 7. UTILIZE A 90° CONNECTOR AT CABLE CONNECTION TO ANTENNA.
- 8. 1/2" CABLE TO BE UTILIZED UNLESS NOTED OTHERWISE.
- 9. VOIDS AROUND CABLES AT CONDUIT OPENINGS SHALL BE FILLED WITH FOAM SEALANT TO PREVENT WATER INTRUSION.







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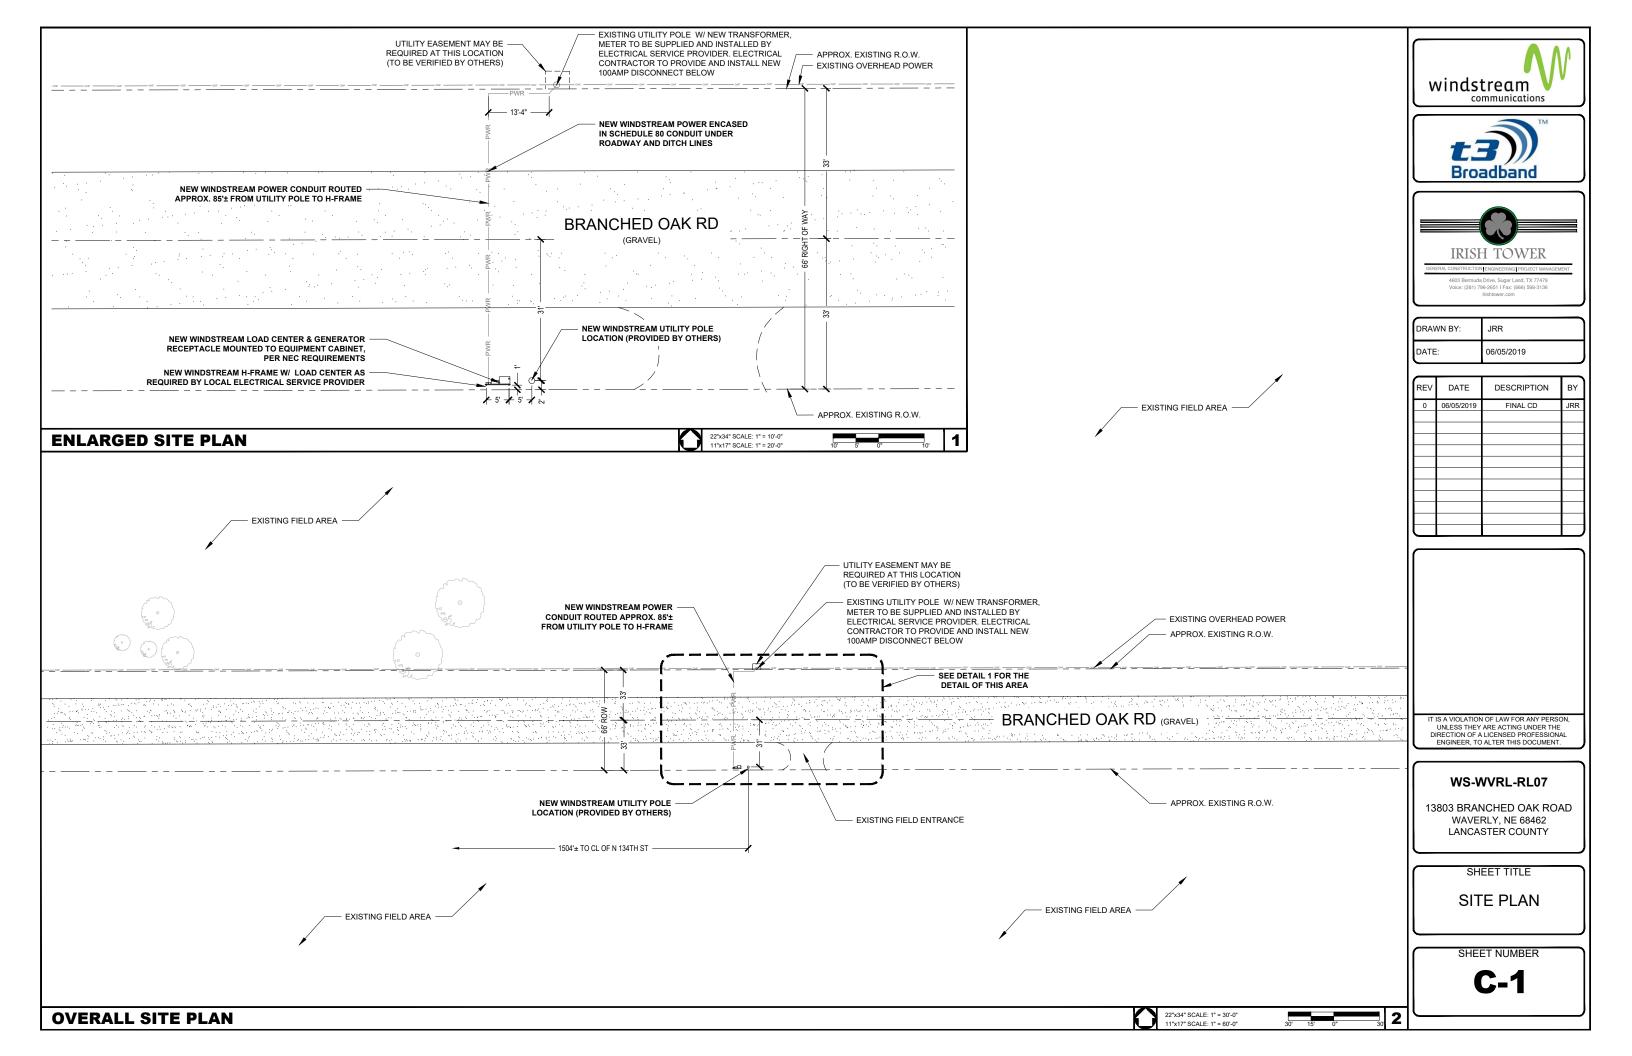
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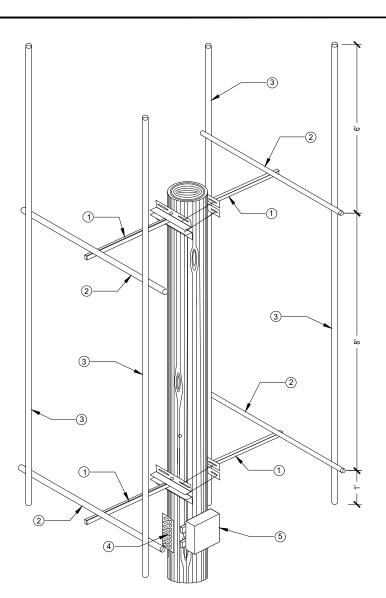
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13803 BRANCHED OAK ROAD WAVERLY, NE 68462 LANCASTER COUNTY


SHEET TITLE
GENERAL
NOTES

SHEET NUMBER





- 1 FOUR 2.5' WOOD POLE STAND-OFFS, TWO MOUNTED BACK-TO-BACK AT 99', ONE AT 45° AND ONE AT 225° EACH SECURED TO THE POLE WITH TWO 4" GALVANIZED LAG BOLTS. THE STAND-OFFS WILL BE CONNECT TO EACH OTHER WITH FOUR 5/8" ALL-THREAD AND GALVANIZED HARDWARE. THE OTHER TWO WOOD POLE STAND-OFFS WILL BE MOUNTED AN 91' IN THE SAME MANNER AS THE TOP STAND-OFFS.
- 2) HORIZONTAL PIPE: FOUR 1.66" OD X 5' LONG PIPES (MADE BY CUTTING A 10' LENGTHS OF PIPE IN HALF) WILL BE MOUNTED ONE EACH TO EACH OF THE FOUR 2.5' WOOD POLE STAND-OFF MOUNTS INSTALLED IN THE PREVIOUS STEP. THE CENTER OF EACH HORIZONTAL PIPE SHOULD ATTACH TO END OF EACH OF THE STAND-OFF MOUNTS UTILIZING A PIPE CROSSOVER MOUNT (PN-SINCLAMPO17) TO MAKE THE CONNECTION.
- ③ VERTICAL PIPES: FOUR VERTICAL 1.66" OD X 15'GALVANIZED PIPES ARE USED TO COMPLETE THE POLE TOP MOUNT. ONE EACH OF THE VERTICAL PIPES WILL ATTACH TO THE ENDS OF THE UPPER AND LOWER HORIZONTAL PIPES. EACH VERTICAL PIPE SHOULD ATTACH 2" IN FROM THE END OF THE HORIZONTAL PIPES WITH ~6' OF PIPE EXTENDING ABOVE THE UPPER HORIZONTAL PIPE AND ~12" OF PIPE EXTENDING BELOW THE LOWER HORIZONTAL PIPE. EACH VERTICAL PIPE WILL BE CONNECTED TO THE HORIZONTAL PIPES WITH TWO PIPE CROSS-OVER MOUNTS (PNSINCLAMPO17) ONE ON THE TOP HORIZONTAL PIPE AND ONE ON THE BOTTOM.
  DURING FINAL ASSEMBLE A LEVEL SHOULD BE USED TO ASSURE THAT THE VERTICAL PIPES ARE INSTALL PLUMB IN EACH DIRECTION.
- (4) PTMP RAD CENTER GROUND BAR SHOULD BE ATTACHED TO THE POLE UTILIZING THE INCLUDED ISOLATION MOUNTS AND HARDWARE, 12" BELOW THE BOTTOM 2.5' STAND-OFF MOUNTS.
- (5) PTMP RAD CENTER OUTDOOR ENCLOSURE (PN-AM32P-2625-16RU) SHOULD BE ATTACHED TO THE POLE 1' ABOVE THE BOTTOM MOUNT. A 16" UNISTRUT SHOULD BE SECURED TO THE POLE USING A 4" GALVANIZED LAG BOT. THE ENCLOSURE SHOULD BE MOUNTED TO THE UNISTRUT UTILIZING THE SPRING NUT AND BOLT

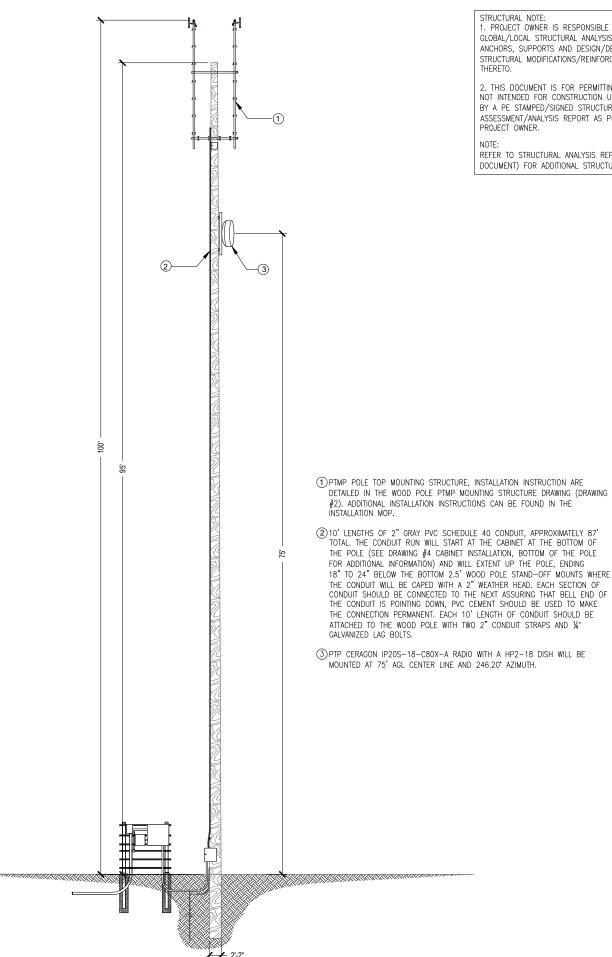

STRUCTURAL NOTE:

. PROJECT OWNER IS RESPONSIBLE FOR PROVIDING A GLOBAL/LOCAL STRUCTURAL ANALYSIS OF EQUIPMENT ANCHORS, SUPPORTS AND DESIGN/DETAILING OF ANY STRUCTURAL MODIFICATIONS/REINFORCEMENT REQUIRED

2. THIS DOCUMENT IS FOR PERMITTING ONLY AND IS NOT INTENDED FOR CONSTRUCTION UNLESS ACCOMPANIED BY A PE STAMPED/SIGNED STRUCTURAL ASSESSMENT/ANALYSIS REPORT AS PROVIDED BY THE PROJECT OWNER.

REFER TO STRUCTURAL ANALYSIS REPORT (SEPARATE DOCUMENT) FOR ADDITIONAL STRUCTURAL INFORMATION.







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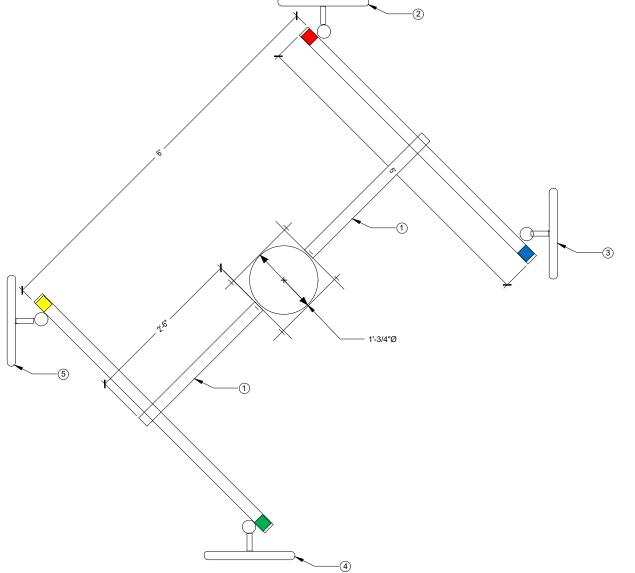
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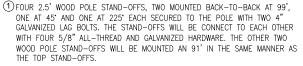
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13803 BRANCHED OAK ROAD WAVERLY, NE 68462 LANCASTER COUNTY

> SHEET TITLE **ELEVATION DETAILS**

SHEET NUMBER





- ② AZIMUTH 01 (0' NORTH) HAS A SINGLE BS AT 99'ACL, 0' AZIMUTH WITH 0' PHYSICAL DOWN TILT AND PROVISIONED WITH A 40 MHZ WIDE CHANNEL IN THE 5.8 GHZ RANGE (SEE RFDS FOR SPECIFIC FREQUENCY. AZIMUTH 01 (NORTH) IS LABELED WITH RED TAPE, THE TOP OF THE PIPE IS MARKED WITH A SINGLE WRAP OF RED TAPE. THE BS SHOULD HAVE A SINGLE WRAP OF RED TAPE ON EACH END OF THE FOLLOWING CABLES; THE JUMPER CABLE BETWEEN THE LPU AND THE BS, THE VERTICAL CABLE RUN BETWEEN THE TOP LPU AND THE BOTTOM LPU AND THE JUMPER BETWEEN THE BOTTOM LPU AND POE SWITCH PORT.
- (3) AZIMUTH 02 (90' EAST) HAS A SINGLE BS AT 99'ACL, 90' AZIMUTH WITH 0' PHYSICAL DOWN TILT AND PROVISIONED WITH A 40 MHZ WIDE CHANNEL IN THE 5.8 GHZ RANGE (SEE RFDS FOR SPECIFIC FREQUENCY. AZIMUTH 02 (EAST) IS LABELED WITH BLUE TAPE, THE TOP OF THE PIPE IS MARKED WITH A SINGLE WRAP OF BLUE TAPE. THE BS SHOULD HAVE A SINGLE WRAP OF BLUE TAPE ON EACH END OF THE FOLLOWING CABLES; THE JUMPER CABLE BETWEEN THE LPU AND THE BS, THE VERTICAL CABLE RUN BETWEEN THE TOP LPU AND THE BOTTOM LPU AND THE JUMPER BETWEEN THE BOTTOM LPU AND POE SWITCH PORT.
- (4) AZIMUTH 03 (180° SOUTH) HAS A SINGLE BS AT 99'ACL, 180° AZIMUTH WITH 0° PHYSICAL DOWN TILT AND PROVISIONED WITH A 40 MHZ WIDE CHANNEL IN THE 5.8 GHZ RANGE (SEE RFDS FOR SPECIFIC FREQUENCY. AZIMUTH 03 (SOUTH) IS LABELED WITH GREEN TAPE, THE TOP OF THE PIPE IS MARKED WITH A SINGLE WRAP OF GREEN TAPE. THE BS SHOULD HAVE A SINGLE WRAP OF GREEN TAPE ON EACH END OF THE FOLLOWING CABLES; THE JUMPER CABLE BETWEEN THE LPU AND THE BS, THE VERTICAL CABLE RUN BETWEEN THE TOP LPU AND THE BOTTOM LPU AND THE JUMPER BETWEEN THE BOTTOM LPU AND POE SWITCH PORT.
- (\$) AZIMUTH 04 (270' WEST) HAS A SINGLE BS AT 99'ACL, 270' AZIMUTH WITH 0' PHYSICAL DOWN TILT AND PROVISIONED WITH A 40 MHZ WIDE CHANNEL IN THE 5.8 GLT RANGE (SEE RFDS FOR SPECIFIC FREQUENCY, AZIMUTH 03 (SOUTH) IS LABELED WITH YELLOW TAPE, THE TOP OF THE PIPE IS MARKED WITH A SINGLE WRAP OF YELLOW TAPE. THE BS SHOULD HAVE A SINGLE WRAP OF YELLOW TAPE NO FITHE FOLLOWING CABLES; THE JUMPER CABLE BETWEEN THE LPU AND THE BS, THE VERTICAL CABLE RUN BETWEEN THE TOP LPU AND THE BOTTOM LPU AND THE JUMPER BETWEEN THE BOTTOM LPU AND POE SWITCH PORT.







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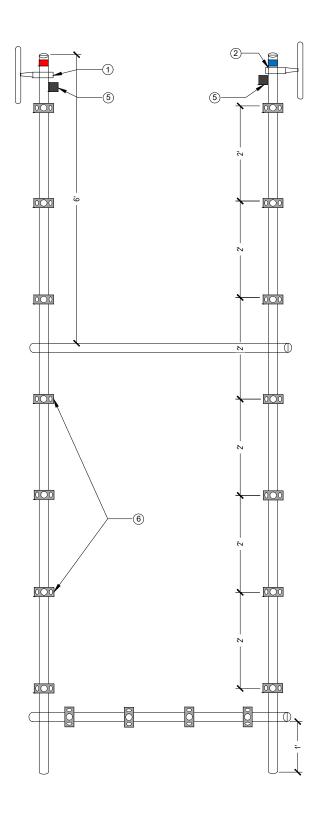
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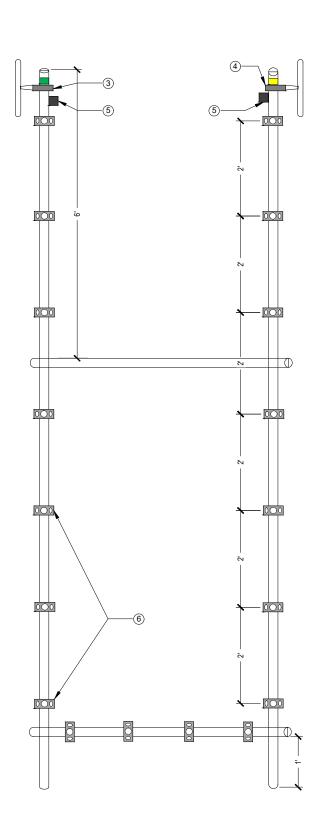
13803 BRANCHED OAK ROAD WAVERLY, NE 68462 LANCASTER COUNTY

SHEET TITLE
ANTENNA LAYOUT
DETAILS

SHEET NUMBER

**C**-3





- ① AZIMUTH 01 (0° NORTH) HAS A SINGLE BS AT 99'ACL, 0° AZIMUTH WITH 0° PHYSICAL DOWN TILT AND PROVISIONED WITH A 40 MHZ WIDE CHANNEL IN THE 5.8 GHZ RANGE. AZIMUTH 01 IS LABELED WITH RED TAPE, THE TOP OF THE PIPE IS MARKED WITH A SINGLE WRAP OF RED TAPE. THE BS SHOULD HAVE A SINGLE WRAP OF RED TAPE ON EACH END OF THE FOLLOWING CABLES; THE JUMPER CABLE BETWEEN THE LPU AND THE BS, THE VERTICAL CABLE RUN BETWEEN THE TOP LPU AND THE BOTTOM LPU AND THE JUMPER BETWEEN THE BOTTOM LPU AND POE SWITCH PORT.
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- (5) POLE TOP LIGHTNING PROTECTION UNITS (LPU): EACH BASE STATION WILL HAVE ONE POLE TOP LPU MOUNTED 2" BELOW THE BS MOUNTING CLAMP 180' OPPOSITE THE BS. FOLLOW THE CABLE INSTALLATION INSTRUCTIONS INCLUDED WITH THE LPU WHEN CABLING THE LPU.
- (6) THREE HOLE UNIVERSAL SNAP—IN ADAPTORS SHOULD BE ATTACHED TO EACH OF THE VERTICAL PIPES EVERY 2', AND THE LOWER HORIZONTAL PIPE EVERY 1' TO ACCOMMODATE THE APPROPRIATE SNAP HANGERS AND GROMMETS FOR PROPER CABLE SUPPORT. NOTE: ALTHOUGH SHOWN IN THE PHOTO FOR ILLUSTRATIVE PURPOSES, VERTICAL PIPES WITHOUT BASE STATION SHOULD NOT HAVE UNIVERSAL SNAP—IN ADAPTORS INSTALLED.







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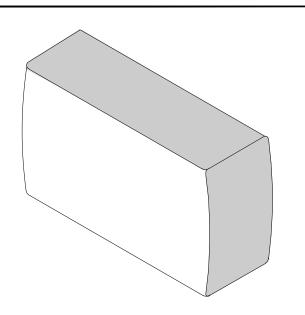
13803 BRANCHED OAK ROAD WAVERLY, NE 68462 LANCASTER COUNTY

SHEET TITLE
STRUCTURE
DETAILS


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**NEW STRUCTURE DETAILS** 



	BAS	E STATION
ı	MANUF:	RADWIN
ı	PART #:	RW-5BG5-0649
ı	HEIGHT:	8.86"
ı	WIDTH:	14.01"
ı	DEPTH:	3.7"
l	WEIGHT:	7.28 LBS



LIGHTNING PROTECTION		
MANUF:	RADWIN	
PART #:	RW-9924-0106	
HEIGHT:	2.04"	
WIDTH:	3.87"	
DEPTH:	1.88"	
WEIGHT:	0.49 LBS	

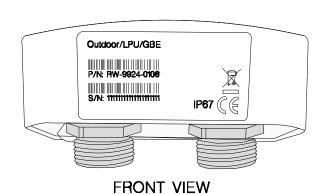

CABINET		
_	ADINE	
MANUF:	WESTELL	
PART #:	BXM1019-NHE3	
HEIGHT:	22.5"	
WIDTH:	25.5"	
DEPTH:	27.8"	
WEIGHT:	70.00 LBS	







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#### WS-WVRL-RL07

13803 BRANCHED OAK ROAD WAVERLY, NE 68462 LANCASTER COUNTY

SHEET TITLE
EQUIPMENT
DETAILS

SHEET NUMBER


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**D-1** 


# LIGHTNING PROTECTOR

H-FRAME DETAIL

# 2 | WESTELL BOXER OUTDOOR CABINET

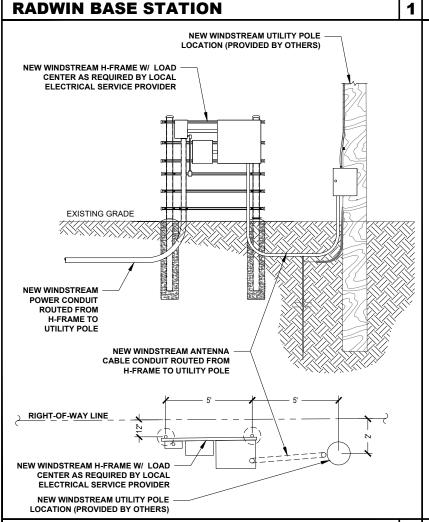


**DETAIL RACK ELEVATION** 

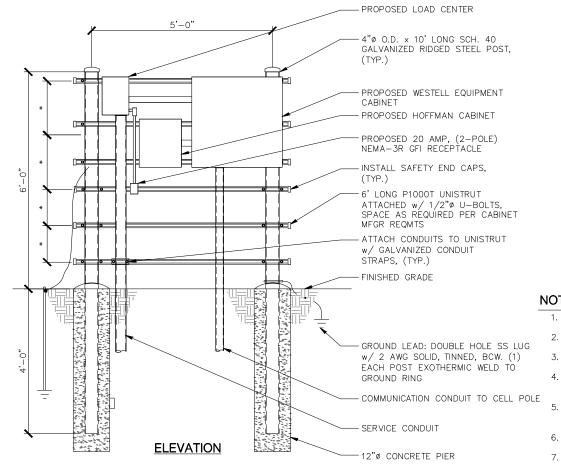


NOTES:

- 1. \*- COORDINATE ELEVATIONS WITH EQUIPMENT/MOUNTING HEIGHT.
- 2. STEEL SHALL BE HOT DIP GALVANIZED.
- 3. CABINETS SHALL BE MOUNTED WITH STAINLESS STEEL BOLTS.
- 4. METAL POSTS ARE NOT ALLOWED TO SERVE AS EQUIPMENT GROUNDING CONDUCTOR.
- 5. UNISTRUT SHALL NOT EXTEND BEYOND POST & MUST HAVE SAFETY END CAPS FOR SAFETY REASONS.
- 6. METALLIC PARTS SHALL BE BONDED ACCORDING TO THE NEC.
- 7. GROUNDING SHALL CONFORM TO NEC AND SECTION 436-439.

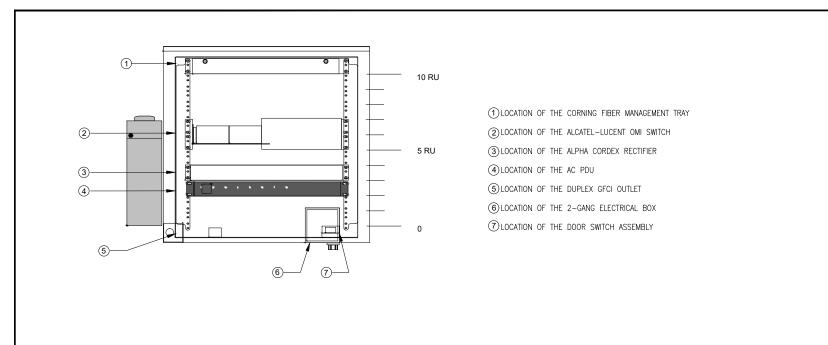

**CABINET DETAIL** 

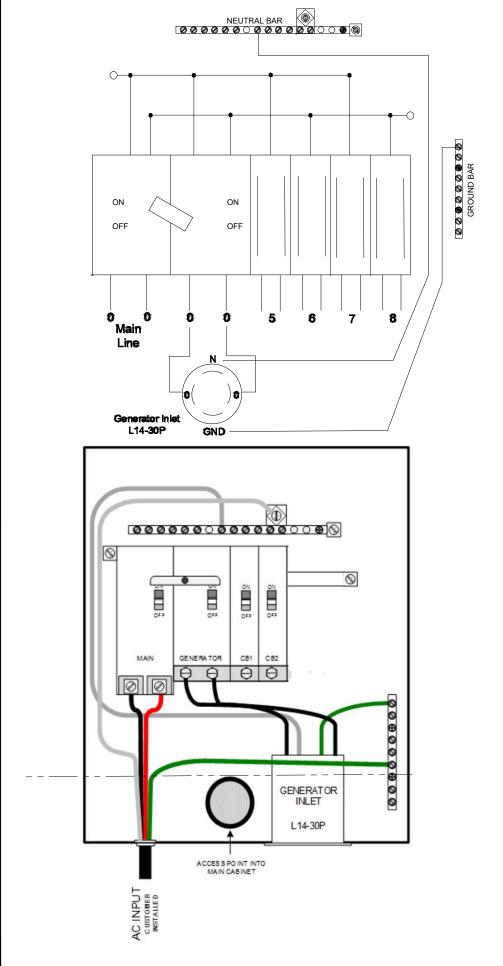







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13803 BRANCHED OAK ROAD WAVERLY, NE 68462 LANCASTER COUNTY

SHEET TITLE
ELECTRICAL &
GROUNDING
DETAILS

SHEET NUMBER

**E-1** 

NOT USED 2 LOAD CENTER 3



# WS-RYMN-RL02

4412 WEST AGNEW ROAD VALPARAISO, NE 68065

# SITE INFORMATION

SITE ID: 4412 WEST AGNEW ROAD VALPARAISO, NE 68065 ADDRESS: LANCASTER COUNTY LATITUDE: LONGITUDE:

JURISDICTION: LANCASTER COUNTY


#### **CONTACTS**

PROJECT MANAGER

PROFESSIONAL ENGINEER: IRISH TOWER, LLC 4603 BERMUDA DRIVE

SUGAR LAND, TEXAS 77479

PROPERTY OWNER:

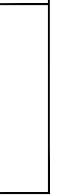

#### **GENERAL NOTES**

THE FACILITY IS NOT FOR HUMAN HABITATION. A TECHNICIAN WILL VISIT THE SITE AS REQUIRED FOR ROUTINE MAINTENANCE. THE PROJECT WILL NOT RESULT IN ANY SIGNIFICANT DISTURBANCE OR EFFECT ON DRAINAGE; NO SANITARY SEWER SERVICE, POTABLE WATER, OR TRASH DISPOSAL IS REQUIRED AND NO COMMERCIAL SIGNAGE IS NEW. THE SITE LOCATION IS SUBJECT TO MOVING, UP TO 10 FROM PROPOSED LOCATION, AS NEEDED TO KEEP WITHIN PUBLIC ROW, AVOID EXISTING THAT Y LINES, AND AVOID LINE-OS-SIGHT OBSTRUCTIONS WITH BOTH FOOT AND AUTOMITVE TRAFFIC. CONTRACTOR SHALL NOTIFY ENGINEER OF RECORD PRIOR TO ANY CHANGES.



#### PROJECT DESCRIPTION

THESE DRAWINGS DEPICT AN UTILITY POLE WITH ANTENNA INSTALLATION TO PROVIDE HIGH SPEEL NTERNET SERVICE IN RURAL AREAS. THIS INSTALLATION SHALL CONSIST OF THE PLACEMENT OF A NEW POLE, FOUR (4) ANTENNAS, ONE (1) MICROWAVE DISH AND RADIO, ONE (1) CONCEALMENT CABINET AND ASSOCIATED ELECTRICAL COMPONENTS AND MOUNTING BRACKETS AS REQUIRED

### **ENGINEERING**

ALL WORK AND MATERIALS SHALL BE PERFORMED AND INSTALLED IN

2011 NATIONAL ELECTRICAL CODE 2012 INTERNATIONAL BUILDING CODE 2012 INTERNATIONAL MECHANICAL CODE 2012 INTERNATIONAL PLUMBING CODE 2012 LIFE SAFETY CODE (NFPA 101)

2012 INTERNATIONAL FIRE CODE CITY AND/OR COUNTY ORDINANCES LOCAL BUILDING CODE(S) ANSI EIA/TIA 222-G

DRAWING INDEX		
SHEET NO:	SHEET TITLE	
T-1	TITLE SHEET	
T-2	GENERAL NOTES	
C-1	SITE PLANS	
C-2	ELEVATION DETAILS	
C-3	ANTENNA LAYOUT DETAILS	
D-1	EQUIPMENT DETAILS	
E-1	ELECTRICAL & GROUNDING DETAILS	

NOTE: DRAWINGS ARE SCALED TO 11X17

CONTRACTOR SHALL VERIFY ALL PLANS & CONTRACTOR STALL VENIET ALE PLANS & EXISTING DIMENSIONS & CONDITIONS ON THE JOB SITE & SHALL IMMEDIATELY NOTIFY THE ARCHITECT OR ENGINEER IN WRITING OF ANY DISCREPANCIES BEFORE PROCEEDING WITH THE WORK OR BE RESPONSIBLE FOR SAME.









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4412 WEST AGNEW ROAD VALPARAISO, NE 68065 LANCASTER COUNTY

SHEET TITLE

TITLE SHEET

SHEET NUMBER

#### GENERAL NOTES

- 1. THE CONTRACTOR SHALL BE RESPONSIBLE FOR SURVEY MONUMENTS AND/OR VERTICAL CONTROL BENCHMARKS WHICH ARE DISTURBED OR DAMAGED BY CONSTRUCTION. A LAND SURVEYOR MUST FIELD LOCATE, REFERENCE, AND/OR PRESERVE ALL HISTORICAL OR CONTROLLING MONUMENTS PRIOR TO ANY EARTHWORK. IF DAMAGED, SUCH MONUMENTS SHALL BE REPLACED WITH APPROPRIATE MONUMENTS BY A LAND SURVEYOR. A CORNER RECORD OR RECORD OF SURVEY, AS APPROPRIATE, SHALL BE FILED AS REQUIRED BY THE PROFESSIONAL LAND SURVEYORS ACT.
- 2. IMPORTANT NOTICE: CONTRACTOR SHALL CALL LOCAL UNDERGROUND LOCATE SERVICE THREE WORKING DAYS BEFORE ANY CONSTRUCTION.
- 3. CONTRACTOR SHALL BE RESPONSIBLE FOR LOCATING ALL EXISTING UTILITIES WITHIN PROPOSED EXCAVATIONS AND MUST MAINTAIN MINIMUM VERTICAL AND HORIZONTAL CLEARANCES AS CALLED FOR BY LOCAL CODES AND/OR ORDINANCES.
- 4. CONTRACTOR IS RESPONSIBLE FOR REPAIR AND/OR REPLACEMENT OF ANY EXISTING STRUCTURES OR LANDSCAPING DAMAGED DURING CONSTRUCTION.
- 5. CONTRACTOR SHALL REPLACE OR REPAIR ALL TRAFFIC SIGNAL LOOPS, CONDUIT, AND LANE STRIPING DAMAGED DURING CONSTRUCTION.
- 6. THIS PROJECT WILL BE INSPECTED BY ENGINEERING AND FIELD ENGINEERING DIVISION.
- 7. ANY MANHOLES OR COVERS INSTALLED AS PART OF THIS PROJECT SHALL BE LABELED COMMUNICATIONS.
- 8. THE CONTRACTOR SHALL BE RESPONSIBLE FOR IMPLEMENTATION OF AN EROSION CONTROL PLAN WHICH MEETS ALL APPLICABLE REQUIREMENTS OF STATE AND LOCAL AGENCIES HAVING JURISDICTION.
- 9. THE CONTRACTOR SHALL MAINTAIN MATERIALS AND EQUIPMENT ON SITE FOR UNFORESEEN SITUATIONS INCLUDING DAMAGE TO UNDERGROUND WATER, SEWER, AND STORM DRAIN FACILITIES WHICH COULD GENERATE FLOWS ABLE TO CAUSE EROSION AND SEDIMENT POLITICION

#### SPECIAL NOTES

- 1. INDEMNIFICATION CLAUSE: THE CONTRACTOR AGREES AND SHALL: ASSUME SOLE AND COMPLETE RESPONSIBILITY OF THE JOB SITE CONDITIONS DURING THE COURSE OF CONSTRUCTION OF THIS PROJECT, INCLUDING THE SAFETY OF ALL PERSONS AND PROPERTIES. THESE REQUIREMENTS SHALL APPLY CONTINUOUSLY AND NOT BE LIMITED TO NORMAL WORKING HOURS AND CONDITIONS. THE CONTRACTOR FURTHER AGREES TO DEFEND INDEMNITY AND HOLD OWNER, REPRESENTATIVES, AND ENGINEERS HARMLESS FROM ANY AND ALL LIABILITY, REAL OR ALLEGED IN CONNECTION WITH THE PERFORMANCE OF THE WORK ON THIS PROJECT.
- 2. PRIOR TO START OF CONSTRUCTION AND THROUGH PROJECT COMPLETION, THE CONTRACTOR SHALL REMAIN IN FULL COMPLIANCE WITH CURRENT FEDERAL, STATE, AND LOCAL OCCUPATIONAL HEALTH AND SAFETY REGULATIONS.
- 3. ALL WORK SHALL CONFORM TO THE LATEST STANDARD "SPECIFICATIONS FOR PUBLIC WORKS CONSTRUCTION" AS ADOPTED BY THE CITY, COUNTY OR STATE AND AS MODIFIED BY STANDARD PLANS AND ADDENDUMS.
- 4. ALL UTILITIES AND OTHER FACILITIES DEPICTED ON THE PLANS ARE BASED ON A SEARCH OF AVAILABLE RECORDS AND FIELD OBSERVATIONS. THE CONTRACTOR SHALL VERIFY PRIOR TO CONSTRUCTION START AND USE EXTREME CARE AND PROTECTIVE MEASURES TO AVOID DAMAGE TO ANY FACILITIES WETHER OR NOT INDICATED ON THESE PLANS. THE CONTRACTOR IS RESPONSIBLE FOR THE PROTECTION OF ALL FACILITIES WITHIN THE LIMITS OF WORK, WHETHER OR NOT DEPICTED ONT THESE PLANS.
- 5. THE CONTRACTOR SHALL BE RESPONSIBLE FOR NOTIFICATION OF ANY CITY, COUNTY OR STATE ENGINEER INSPECTION DEPARTMENT A MINIMUM TWO DAYS PRIOR TO COMMENCEMENT OF ACTIVITY REQUIRING THEIR INVOLVEMENT.
- 6. THE EXPIRATION OF THE PERMIT FOR THIS PROJECT SHALL BE SPECIFIED BY THE LOCAL AUTHORITY HAVING JURISDICTION.
- 7. ALL UNDERGROUND CONDUITS PLACED AS PART OF THIS PROJECT MUST HAVE A MINIMUM COVER OF 48 INCHES UNLESS OTHERWISE APPROVED.
- 8. THE CONTRACTOR SHALL TUNNEL ALL CURB AND GUTTERS AND BORE ALL CONCRETE DRIVEWAYS AND WALKWAYS AT THE DIRECTION OF THE CITY, COUNTY OR STATE ENGINEER HAVING JURISDICTION.
- 9. ALL PAVEMENT CUT OR DAMAGED AS PART OF THIS PROJECT SHALL BE REPLACED AT THE DIRECTION OF THE CITY, COUNTY OR STATE ENGINEER HAVING JURISDICTION.
- 10. ALL SHRUBS, PLANTS OR TREES DAMAGED OR DISTURBED DURING THE COURSE OF THE WORK, SHALL BE REPLANTED AND/OR REPLACED SO AS TO RESTORE THE WORK SITE TO ITS ORIGINAL CONDITION.
- 11. THE CONTRACTOR SHALL BE RESPONSIBLE FOR PROCESSING OF ALL APPLICANT PERMIT FORMS ALONG WITH REQUIRED LIABILITY INSURANCE FORMS CLEARLY DEMONSTRATING OWNER, OWNER REPRESENTATIVES, ENGINEER, AND CITY, COUNTY OR STATE ARE ALSO INSURED WITH THE REQUIRED LIABILITY INSURANCE FOR THIS CONSTRUCTION PROJECT.
- 12. ALL SUBSURFACE STRUCTURES INCLUDING BUT NOT LIMITED TO VAULTS, PEDESTALS, AND CONDUITS SHALL BE AS SPECIFIED IN THESE PLANS OR AS SPECIFIED BY THE ENGINEER. ANY DEVIATIONS SHALL BE APPROVED BY THE ENGINEER IN WRITING PRIOR TO INSTALLATION.
- 13. THE CONTRACTOR IS RESPONSIBLE FOR VERIFICATION OF ALL EXISTING UTILITIES, INCLUDING BUT NOT LIMITED TO SEWER LATERALS AND WATER SERVICES, BOTH VERTICAL AND HORIZONTAL, PRIOR TO COMMENCING IMPROVEMENT OPERATIONS.
- 14. THE CONTRACTOR IS RESPONSIBLE FOR COMPLETION OF EXPLORATION EXCAVATIONS CONDUCTED FOR THE PURPOSE OF LOCATING EXISTING FACILITIES SUFFICIENTLY AHEAD OF CONSTRUCTION TO PERMIT REVISIONS TO PLANS AS REQUIRED.
- 15. LOCATIONS OF EXISTING UTILITIES ON THESE PLANS ARE BASED UPON EXISTING RECORDS VERIFIED WHERE POSSIBLE WITH FIELD TIES. CONTRACTOR IS RESPONSIBLE FOR VERIFICATION OF LOCATIONS SHOWN, BOTH HORIZONTAL AND VERTICALLY. PRIOR TO CONSTRUCTION, SUBSTANTIAL VARIANCES FROM THE PLANS SHALL BE COMMUNICATED TO THE ENGINEER TO FACILITATE CHANGES TO CONSTRUCTION DRAWINGS AS REQUIRED.

#### EROSION AND SEDIMENT CONTROL NOTES

TEMPORARY EROSION/SEDIMENT CONTROL PRIOR TO COMPLETION OF FINAL IMPROVEMENTS SHALL BE INSTALLED BY CONTRACTOR OR QUALIFIED PERSON AS INDICATED BELOW:

- 1. ALL REQUIREMENTS OF THE CITY, COUNTY AND STATE "STORM WATER STANDARDS" MUST BE INCORPORATED INTO THE DESIGN AND CONSTRUCTION OF THE PROPOSED GRADING/IMPROVEMENTS CONSISTENT WITH THE APPROVED STORM WATER POLLUTION PREVENTION PLAN (SWPPP), WATER QUALITY TECHNICAL REPORT (WQTR), AND/ OR WATER POLLUTION CONTROL PLAN (WPCP).
- 2. A GRAVEL BAG SILT BASIN SHALL BE INSTALLED IMMEDIATELY UPSTREAM OF STORM DRAIN INLETS AS INDICATED ON DETAILS.
- 3. FOR INLETS LOCATED AT SUMPS ADJACENT TO TOP OF SLOPES. THE CONTRACTOR SHALL INSURE WATER DRAINING TO THE SUMP IS DIRECTED INTO THE INLET AND A MINIMUM OF 1.00' FREEBOARD EXISTS AND IS MAINTAINED ABOVE THE TOP OF THE INLET. IF FREEBOARD IS NOT PROVIDED BY GRADING SHOWN ON THESE PLANS THE CONTRACTOR SHALL PROVIDE IT VIA TEMPORARY MEASURES, I.E. GRAVEL BAGS OR DIKES.
- 4. THE CONTRACTOR OR QUALIFIED PERSON SHALL BE RESPONSIBLE FOR CLEANUP OF SILT AND MUD ON ADJACENT STREET(S) AND STORM DRAIN SYSTEM DUE TO CONSTRUCTION ACTIVITY.
- 5. THE CONTRACTOR OR QUALIFIED PERSON SHALL CHECK AND MAINTAIN ALL LINED AND UNLINED DITCHES AFTER EACH RAINFALL.
- 6. THE CONTRACTOR SHALL REMOVE SILT AND DEBRIS AFTER EACH MAJOR RAINFALL.
- 7. THE CONTRACTOR SHALL MAINTAIN EQUIPMENT AND WORKERS FOR EMERGENCY WORK AT ALL TIMES DURING THE RAINY SEASON. MATERIALS NECESSARY FOR EMERGENCY MEASURES SHALL BE STOCKPILED ON SITE AT CONVENIENT LOCATIONS TO FACILITATE RAPID CONSTRUCTION OF TEMPORARY DEVICES WHEN RAIN IS IMMINENT.
- 8. THE CONTRACTOR IS RESPONSIBLE FOR RESTORING ALL EROSION/SEDIMENT CONTROL DEVICES TO WORKING ORDER TO THE SATISFACTION OF THE CITY/COUNTY/STATE ENGINEER OR RESIDENT ENGINEER FOLLOWING ANY RUN-OFF PRODUCING RAINFALL.
- 9. THE CONTRACTOR SHALL INSTALL ADDITIONAL EROSION/SEDIMENT CONTROL MEASURES AS REQUIRED BY THE RESIDENT ENGINEER DUE TO UNCOMPLETED GRADING OPERATIONS OR UNFORESEEN CIRCUMSTANCES.
- 10. THE CONTRACTOR SHALL BE RESPONSIBLE AND TAKE NECESSARY PRECAUTIONS TO PREVENT PUBLIC TRESPASS ONTO AREAS WHERE IMPOUNDED WATERS CREATE A HAZARDOUS CONDITION.
- 11. ALL EROSION/SEDIMENT CONTROL MEASURES PROVIDED PER THE APPROVED GRADING PLAN SHALL BE INCORPORATED HERON. ALL EROSION/SEDIMENT CONTROL FOR INTERIM CONDITIONS SHALL BE DONE TO THE SATISFACTION OF THE RESIDENT ENGINEER.
- 12. UPON COMPLETION OF WORK EACH DAY, GRADED AREAS AROUND THE PROJECT PERIMETER MUST DRAIN AWAY FROM THE FACE OF THE
- 13. ALL REMOVABLE PROTECTIVE DEVICES SHOWN SHALL BE IN PLACE AT THE END OF EACH WORKING DAY WHEN RAIN IS IMMINENT.
- 14. GRADING, INCLUDING CLEARING AND GRUBBING SHALL ONLY BE CONDUCTED IN AREAS WHERE THE CONTRACTOR OR QUALIFIED PERSON CAN PROVIDE EROSION/SEDIMENT CONTROL MEASURES.

#### ROW GROUND CONSTRUCTION NOTES:

- THE CONTRACTOR SHALL REMOVE/CLEAN ALL DEBRIS, NAILS, STAPLES, OR NON-USED
- VERTICALS OFF THE POLE.
- 2. ALL WORK SHALL BE IN ACCORDANCE WITH MUNICIPAL, COUNTY, STATE, AND FEDERAL

#### STANDARDS AND REGULATIONS.

3. THE CONTRACTOR SHALL CALL LOCAL UNDERGROUND LOCATE SERVICE THREE WORKING DAYS

#### BEFORE ANY CONSTRUCTION IS STARTED

- 4. ALL EXISTING LANDSCAPING SHALL BE RESTORED TO ORIGINAL OR BETTER CONDITION.
- 5. ALL EQUIPMENT SHALL BE BONDED.
- 6. IF A METERING CABINET IS INSTALLED, A MINIMUM 3' CLEARANCE IS REQUIRED AT DOOR OPENING.
- 7. IF A METERING CABINET IS INSTALLED, THE CONTRACTOR SHALL CAULK THE CABINET BASE AT THE PAD.

#### STANDARD GROUNDING NOTES:

- 1. GROUND SHALL BE TESTED AT 25 OHMS OR LESS.
- 2. GROUND RODS SHALL BE 5/8"X8'. ATTACHMENT TO GROUND RODS SHALL BE EXOTHERMIC WELD OR UL LISTED DIRECT BURY CLAMP BELOW GRADF.
- 3. BURIED GROUND AND BONDING WIRE SHALL BE #6 AWG.
- 4. MOLDING SHALL BE STAPLED EVERY 1' AND AT EACH END.

#### STANDARD CONDUIT NOTES:

- 1. SCHEDULE 40 CONDUIT SHALL BE USED UNDERGROUND.
- 2. SCHEDULE 80 CONDUIT SHALL BE USED FOR RISERS.
- 3. RISERS SHALL BE ATTACHED TO POLE WITH STANDARD U-CLAMPS AND LAG SCREWS.
- 4. RISER U-CLAMPS TO BE INSTALLED EVERY 5'.
- 5. FOR U/G POWER INSTALLATIONS, 2" SDR-11 RED CONDUIT SHALL BE UTILIZED.
- 6. GROUND WIRE MOLDING STAPLES MAY BE BE UTILIZED FOR ATTACHING CONDUIT LESS THAN 1" DIAMETER.
- 7. ALL CONDUIT SHALL BE PROOFED WITH A MANDREL AND EQUIPPED WITH A PULL ROPE OR MULE TAPE.

#### STANDARD TRENCHING NOTES:

- 1. A MINIMUM OF 2'-6" OF COVER SHALL BE MAINTAINED OVER ALL ELECTRICAL CONDUITS.
- 2. A MINIMUM OF 4'-0" OF COVER SHALL BE MAINTAINED OVER ALL COMMUNICATIONS CONDUITS.
- 3. IN STREETS, SLURRY TO GRADE AND MILL DOWN 1-1/2" FOR AC CAP.
- 4. IN DIRT, SLURRY TO 18" FROM GRADE AND FILL WITH 95% COMPACTION NATIVE SOIL FOR BALANCE.
- 5. WARNING TAPE SHALL BE INSTALLED 1'-O" ABOVE ALL CONDUITS. #18 WARNING TAPE SHALL BE INSTALLED ABOVE GROUND RING.

#### ROW UTILITY POLE CONSTRUCTION NOTES:

- 1. BOLT THREADS SHALL NOT PROTRUDE MORE THAN 1-1/2".
- 2. HOLES LEFT IN POLE DUE TO REARRANGEMENT OF CLIMBERS SHALL BE FILLED.
- 3. CLIMB STEPS ADJACENT TO CONDUIT SHALL HAVE EXTENDED STEPS.
- 4. CABLE SHALL NOT IMPEDE 15" CLEAR SPACE OFF POLE FACE (12:00).
- 5. 90° SHORT SWEEPS SHALL BE USED UNDER ANTENNA ARM. CABLES MUST TRANSITION ON THE INSIDE OR BOTTOM OF ARMS. (NO CABLE SHALL BE INSTALLED ON TOP OF ARMS.)
- 6. CABLE CLAMPS SHALL BE UTILIZED TO SECURE CABLE TO
  ARMS; 2" CARRIER CABLE ID TAGS SHALL BE PLACED ON BOTH SIDES OF
  ARMS
- 7. UTILIZE A 90° CONNECTOR AT CABLE CONNECTION TO ANTENNA.
- 8. 1/2" CABLE TO BE UTILIZED UNLESS NOTED OTHERWISE.
- 9. VOIDS AROUND CABLES AT CONDUIT OPENINGS SHALL BE FILLED WITH FOAM SEALANT TO PREVENT WATER INTRUSION.







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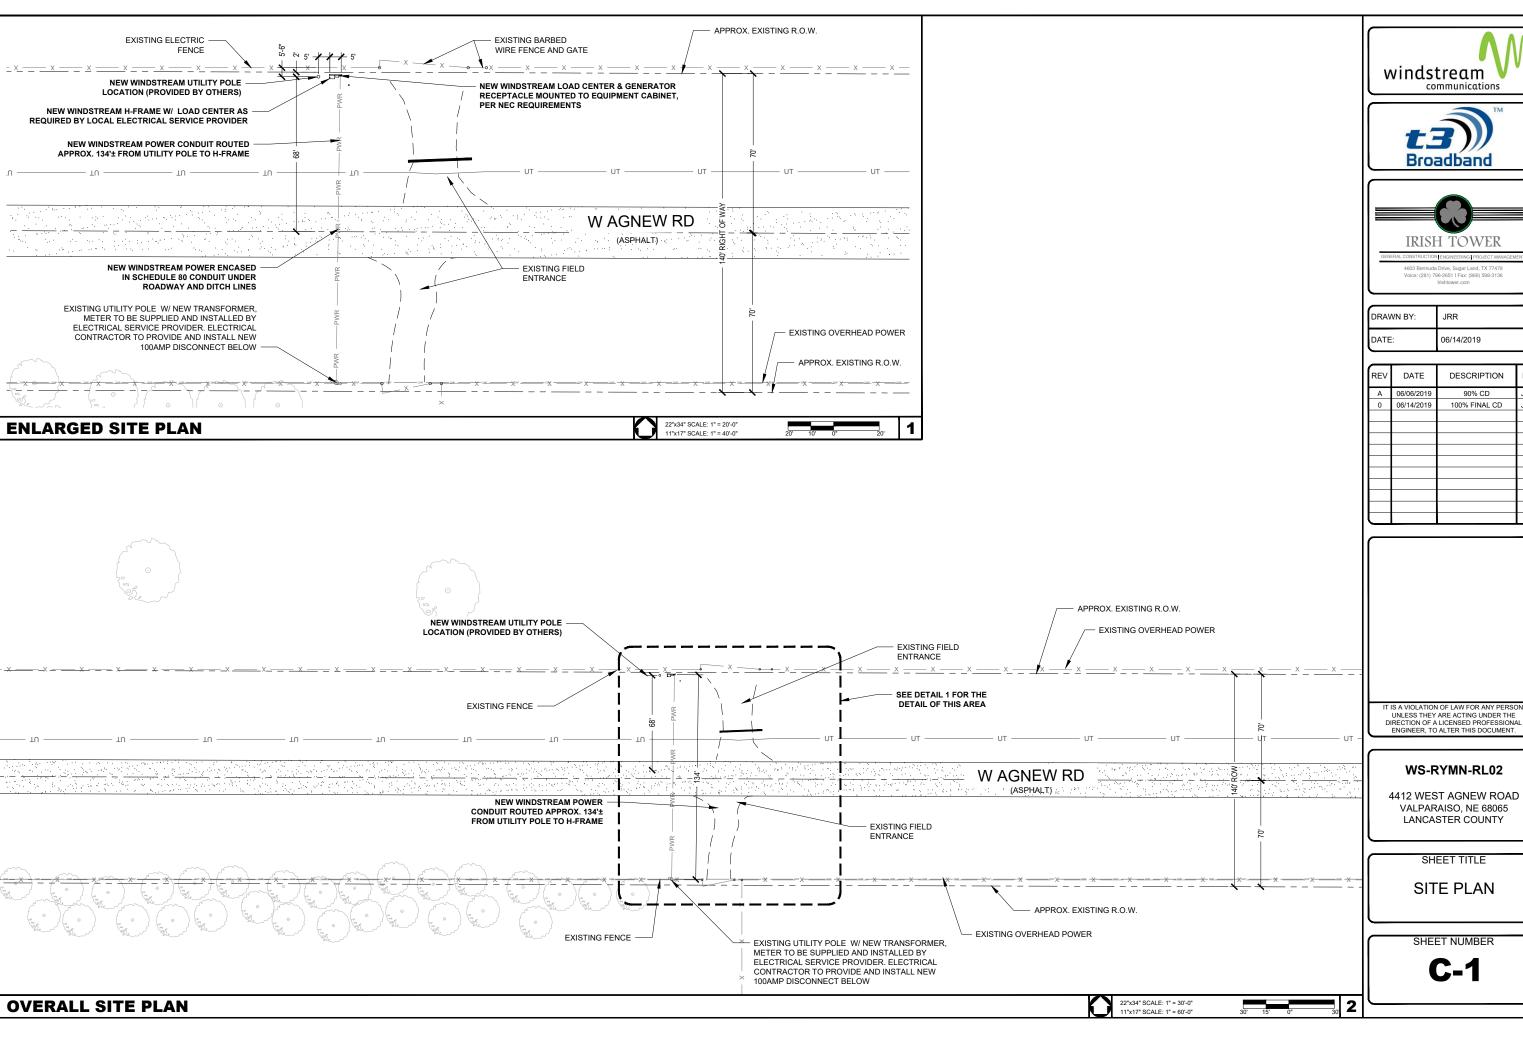
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#### WS-RYMN-RL02

4412 WEST AGNEW ROAD VALPARAISO, NE 68065 LANCASTER COUNTY

SHEET TITLE
GENERAL
NOTES

SHEET NUMBER









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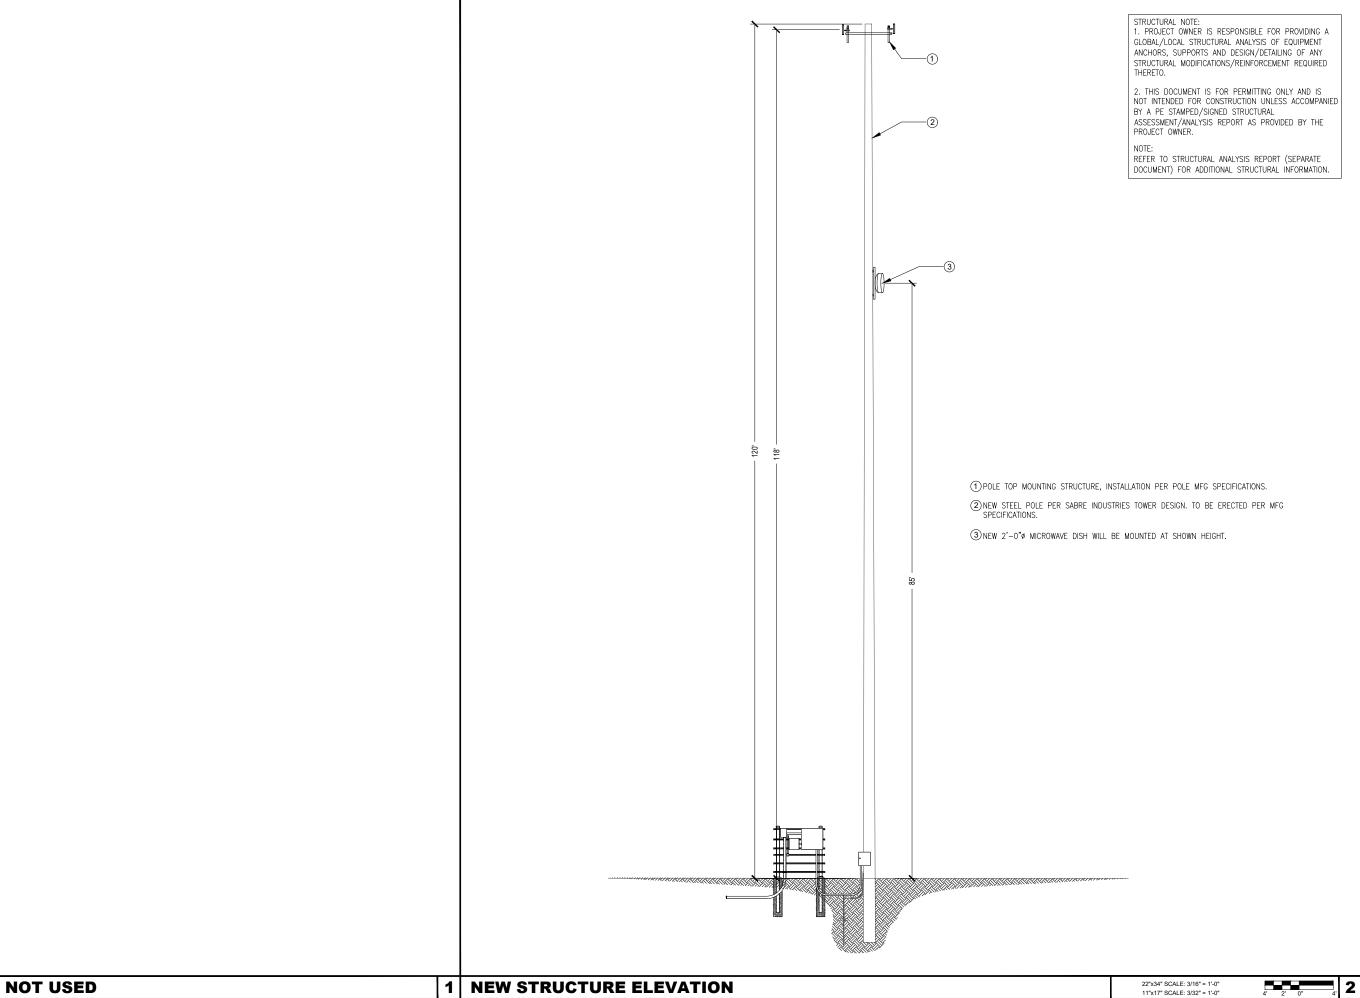
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VALPARAISO, NE 68065 LANCASTER COUNTY

SHEET TITLE

SITE PLAN

SHEET NUMBER









4603 Bermuda Drive, Sugar Land, TX 77479 Voice: (281) 796-2651 | Fax: (866) 598-3136 Irishtower.com

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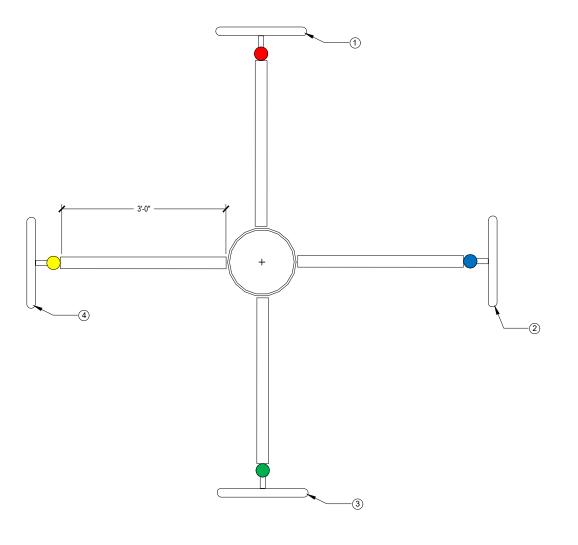
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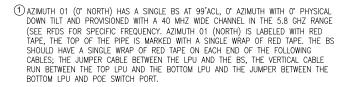
4412 WEST AGNEW ROAD VALPARAISO, NE 68065 LANCASTER COUNTY

SHEET TITLE
ELEVATION
DETAILS

SHEET NUMBER

**C-2** 





- ② AZIMUTH 02 (90° EAST) HAS A SINGLE BS AT 99°ACL, 90° AZIMUTH WITH 0° PHYSICAL DOWN TILT AND PROVISIONED WITH A 40 MHZ WIDE CHANNEL IN THE 5.8 GHZ RANGE (SEE RFDS FOR SPECIFIC FREQUENCY. AZIMUTH 02 (EAST) IS LABELED WITH BLUE TAPE, THE TOP OF THE PIPE IS MARKED WITH A SINGLE WRAP OF BLUE TAPE. THE BS SHOULD HAVE A SINGLE WRAP OF BLUE TAPE ON EACH END OF THE FOLLOWING CABLES; THE JUMPER CABLE BETWEEN THE LPU AND THE BS, THE VERTICAL CABLE RUN BETWEEN THE TOP LPU AND THE BOTTOM LPU AND THE JUMPER BETWEEN THE BOTTOM LPU AND POE SWITCH PORT.
- (3) AZIMUTH 03 (180° SOUTH) HAS A SINGLE BS AT 99°ACL, 180° AZIMUTH WITH 0° PHYSICAL DOWN TILT AND PROVISIONED WITH A 40 MHZ WIDE CHANNEL IN THE 5.8 GHZ RANGE (SEE RFDS FOR SPECIFIC FREQUENCY, AZIMUTH 04 (WEST) IS LABELED WITH GREEN TAPE, THE TOP OF THE PIPE IS MARKED WITH A SINGLE WRAP OF GREEN TAPE. THE BS SHOULD HAVE A SINGLE WRAP OF GREEN TAPE ON EACH END OF THE FOLLOWING CABLES; THE JUMPER CABLE BETWEEN THE LPU AND THE BS, THE VERTICAL CABLE RUN BETWEEN THE TOP LPU AND THE BOTTOM LPU AND THE JUMPER BETWEEN THE BOTTOM LPU AND POE SWITCH PORT.
- (4) AZIMUTH 04 (270' WEST) HAS A SINGLE BS AT 99'ACL, 270' AZIMUTH WITH 0' PHYSICAL DOWN TILT AND PROVISIONED WITH A 40 MHZ WIDE CHANNEL IN THE 5.8 GHZ RANGE (SEE RFDS FOR SPECIFIC FREQUENCY, AZIMUTH 04 (WEST) IS LABELED WITH YELLOW TAPE, THE TOP OF THE PIPE IS MARKED WITH A SINGLE WRAP OF YELLOW TAPE. THE BS SHOULD HAVE A SINGLE WRAP OF YELLOW TAPE ON EACH END OF THE FOLLOWING CABLES; THE JUMPER CABLE BETWEEN THE LPU AND THE BS, THE VERTICAL CABLE RUN BETWEEN THE TOP LPU AND THE BOTTOM LPU AND THE JUMPER BETWEEN THE BOTTOM LPU AND POE SWITCH PORT.







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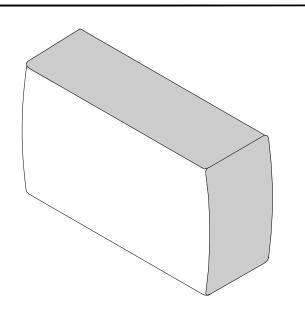
#### WS-RYMN-RL02

4412 WEST AGNEW ROAD VALPARAISO, NE 68065 LANCASTER COUNTY

SHEET TITLE
ANTENNA LAYOUT
DETAILS

SHEET NUMBER

**C**-3



BASE STATION
F: RADWIN

14.01


7.28 LBS

RW-5BG5-0649 8.86"

MANUE

HEIGHT:

EPTH: VEIGHT:

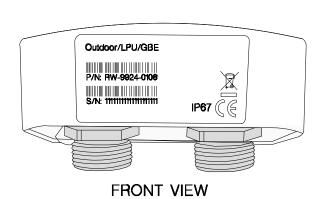

LIGHTNING PROTECTION		
MANUF:	RADWIN	
PART #:	RW-9924-0106	
HEIGHT:	2.04"	
WIDTH:	3.87"	
DEPTH:	1.88"	
WEIGHT:	0.49 LBS	



С	ABINET
MANUF:	WESTELL
PART #:	BXM1019-NHE3
HEIGHT:	22.5"
WIDTH:	25.5"
DEPTH:	27.8"
WEIGHT:	70.00 LBS







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4412 WEST AGNEW ROAD VALPARAISO, NE 68065 LANCASTER COUNTY

SHEET TITLE
EQUIPMENT
DETAILS

SHEET NUMBER


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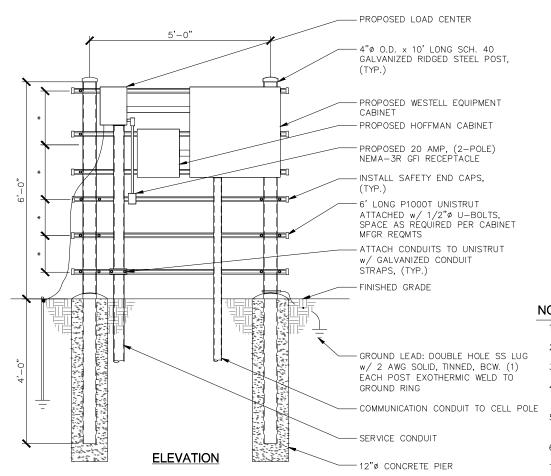
**D-1** 

# LIGHTNING PROTECTOR

H-FRAME DETAIL

# $oldsymbol{2}ig|$ westell boxer outdoor cabinet



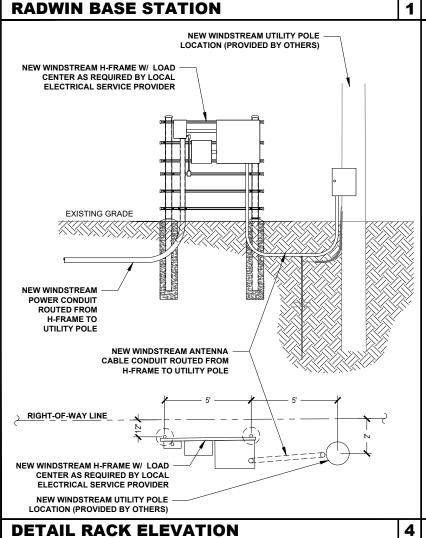



NOTES:

1. \*- COORDINATE ELEVATIONS WITH EQUIPMENT/MOUNTING HEIGHT.

2. STEEL SHALL BE HOT DIP GALVANIZED.

- 3. CABINETS SHALL BE MOUNTED WITH STAINLESS STEEL BOLTS.
- 4. METAL POSTS ARE NOT ALLOWED TO SERVE AS EQUIPMENT GROUNDING CONDUCTOR.
- 5. UNISTRUT SHALL NOT EXTEND BEYOND POST & MUST HAVE SAFETY END CAPS FOR SAFETY REASONS.
- 6. METALLIC PARTS SHALL BE BONDED ACCORDING TO THE NEC.
- 7. GROUNDING SHALL CONFORM TO NEC AND SECTION 436-439.

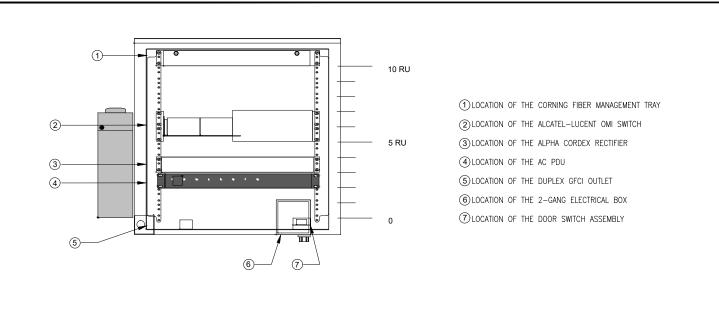

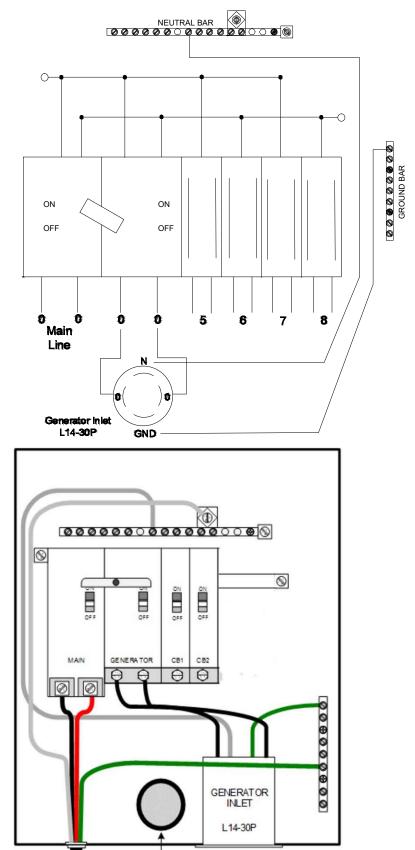







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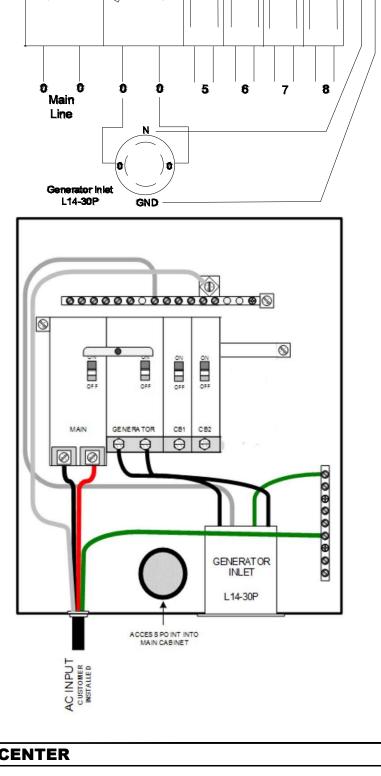
4412 WEST AGNEW ROAD VALPARAISO, NE 68065 LANCASTER COUNTY

SHEET TITLE **ELECTRICAL &** GROUNDING **DETAILS** 

SHEET NUMBER

3

**E-1** 



**NOT USED** 

**CABINET DETAIL** 

2 LOAD CENTER



# WS-RYMN-RL03

7812 WEST DAVEY ROAD RAYMOND, NE 68428

# SITE INFORMATION

SITE ID: 7812 WEST DAVEY ROAD RAYMOND, NE 68428 ADDRESS: COUNTY: LATITUDE: LONGITUDE: 40.9880648\* -96.8259498\*

JURISDICTION: LANCASTER COUNTY

#### **CONTACTS**

PROJECT MANAGER

PROFESSIONAL ENGINEER:

IRISH TOWER, LLC 4603 BERMUDA DRIVE SUGAR LAND, TEXAS 77479

PROPERTY OWNER:

# **GENERAL NOTES**

THE FACILITY IS NOT FOR HUMAN HABITATION. A TECHNICIAN WILL VISIT THE SITE AS REQUIRED FOR ROUTINE MAINTENANCE. THE PROJECT WILL NOT RESULT IN ANY SIGNIFICANT DISTURBANCE OR EFFECT ON DRAINAGE; NO SANITARY SEWER SERVICE, POTABLE WATER, OR TRASH DISPOSAL IS REQUIRED AND NO COMMERCIAL SIGNAGE IS NEW. THE SITE LOCATION IS SUBJECT TO MOVING, UP TO 10 FROM PROPOSED LOCATION, AS NEEDED TO KEEP WITHIN PUBLIC ROW, AVOID EXISTING UTILITY LINES, AND AVOID LINE-OS-SIGHT OBSTRUCTIONS WITH BOTH FOOT AND AUTOMOTIVE TRAFFIC. CONTRACTOR SHALL NOTIFY ENGINEER OF RECORD PRIOR TO ANY CHANGES.



# PROJECT DESCRIPTION

THESE DRAWINGS DEPICT AN UTILITY POLE WITH ANTENNA INSTALLATION TO PROVIDE HIGH SPEEL NTERNET SERVICE IN RURAL AREAS. THIS INSTALLATION SHALL CONSIST OF THE PLACEMENT OF A NEW POLE, FOUR (4) ANTENNAS, ONE (1) MICROWAVE DISH, ONE (1) CONCEALMENT CABINET AND ASSOCIATED ELECTRICAL COMPONENTS AND MOUNTING BRACKETS AS REQUIRED

# **ENGINEERING**

ALL WORK AND MATERIALS SHALL BE PERFORMED AND INSTALLED IN

2011 NATIONAL ELECTRICAL CODE
2012 INTERNATIONAL BUILDING CODE
2012 INTERNATIONAL HECHANICAL CODE
2012 INTERNATIONAL PLUMBING CODE
2012 INTERNATIONAL PLUMBING CODE
3012 INTERNATIONAL PLUMBING CODE
4012 INTERNATIONAL PLUMBING CODE
3013 INTERNATIONAL PLUMBING CODE
3014 INTERNATIONAL PLUMBING CODE
3015 INTERNATIONAL PLUMBING CODE
3015 INTERNATIONAL PLUMBING CODE
3016 INTERNATIONAL PLUMBING CODE
3017 INTERNATIONAL FIRE CODE
3017 ANDIOR COUNTY ORDINANCES
3018 INTERNATIONAL FIRE CODE
3018 INTERNATIONAL FIRE CODE
3018 INTERNATIONAL FIRE CODE
3018 INTERNATIONAL BUILDING CODE
3018 INTERNATIONAL B 2012 INTERNATIONAL PLUMBING CODE 2012 LIFE SAFETY CODE (NFPA 101)

DRAWING INDEX		
SHEET NO:	SHEET TITLE	
T-1	TITLE SHEET	
T-2	GENERAL NOTES	
C-1	SITE PLANS	
C-2	ELEVATION DETAILS	
C-3	ANTENNA LAYOUT DETAILS	
C-4	STRUCTURE DETAILS	
D-1	EQUIPMENT DETAILS	
E-1	ELECTRICAL & GROUNDING DETAILS	
	NOTE: DRAWINGS ARE SCALED TO 11X17	

CONTRACTOR SHALL VERIFY ALL PLANS & CONTRACTOR STALL VENIET ALE PLANS & EXISTING DIMENSIONS & CONDITIONS ON THE JOB SITE & SHALL IMMEDIATELY NOTIFY THE ARCHITECT OR ENGINEER IN WRITING OF ANY DISCREPANCIES BEFORE PROCEEDING WITH THE WORK OR BE RESPONSIBLE FOR SAME.









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#### WS-RYMN-RL03

7812 WEST DAVEY ROAD RAYMOND, NE 68428 LANCASTER COUNTY

SHEET TITLE

TITLE SHEET

SHEET NUMBER

#### GENERAL NOTES

- 1. THE CONTRACTOR SHALL BE RESPONSIBLE FOR SURVEY MONUMENTS AND/OR VERTICAL CONTROL BENCHMARKS WHICH ARE DISTURBED OR DAMAGED BY CONSTRUCTION. A LAND SURVEYOR MUST FIELD LOCATE, REFERENCE, AND/OR PRESERVE ALL HISTORICAL OR CONTROLLING MONUMENTS PRIOR TO ANY EARTHWORK. IF DAMAGED, SUCH MONUMENTS SHALL BE REPLACED WITH APPROPRIATE MONUMENTS BY A LAND SURVEYOR. A CORNER RECORD OR RECORD OF SURVEY, AS APPROPRIATE, SHALL BE FILED AS REQUIRED BY THE PROFESSIONAL LAND SURVEYORS ACT.
- 2. IMPORTANT NOTICE: CONTRACTOR SHALL CALL LOCAL UNDERGROUND LOCATE SERVICE THREE WORKING DAYS BEFORE ANY CONSTRUCTION.
- 3. CONTRACTOR SHALL BE RESPONSIBLE FOR LOCATING ALL EXISTING UTILITIES WITHIN PROPOSED EXCAVATIONS AND MUST MAINTAIN MINIMUM VERTICAL AND HORIZONTAL CLEARANCES AS CALLED FOR BY LOCAL CODES AND/OR ORDINANCES.
- 4. CONTRACTOR IS RESPONSIBLE FOR REPAIR AND/OR REPLACEMENT OF ANY EXISTING STRUCTURES OR LANDSCAPING DAMAGED DURING CONSTRUCTION.
- 5. CONTRACTOR SHALL REPLACE OR REPAIR ALL TRAFFIC SIGNAL LOOPS, CONDUIT, AND LANE STRIPING DAMAGED DURING CONSTRUCTION.
- 6. THIS PROJECT WILL BE INSPECTED BY ENGINEERING AND FIELD ENGINEERING DIVISION.
- 7. ANY MANHOLES OR COVERS INSTALLED AS PART OF THIS PROJECT SHALL BE LABELED COMMUNICATIONS.
- 8. THE CONTRACTOR SHALL BE RESPONSIBLE FOR IMPLEMENTATION OF AN EROSION CONTROL PLAN WHICH MEETS ALL APPLICABLE REQUIREMENTS OF STATE AND LOCAL AGENCIES HAVING JURISDICTION.
- 9. THE CONTRACTOR SHALL MAINTAIN MATERIALS AND EQUIPMENT ON SITE FOR UNFORESEEN SITUATIONS INCLUDING DAMAGE TO UNDERGROUND WATER, SEWER, AND STORM DRAIN FACILITIES WHICH COULD GENERATE FLOWS ABLE TO CAUSE EROSION AND SEDIMENT POLITICION

#### SPECIAL NOTES

- 1. INDEMNIFICATION CLAUSE: THE CONTRACTOR AGREES AND SHALL: ASSUME SOLE AND COMPLETE RESPONSIBILITY OF THE JOB SITE CONDITIONS DURING THE COURSE OF CONSTRUCTION OF THIS PROJECT, INCLUDING THE SAFETY OF ALL PERSONS AND PROPERTIES. THESE REQUIREMENTS SHALL APPLY CONTINUOUSLY AND NOT BE LIMITED TO NORMAL WORKING HOURS AND CONDITIONS. THE CONTRACTOR FURTHER AGREES TO DEFEND INDEMNITY AND HOLD OWNER, REPRESENTATIVES, AND ENGINEERS HARMLESS FROM ANY AND ALL LIABILITY, REAL OR ALLEGED IN CONNECTION WITH THE PERFORMANCE OF THE WORK ON THIS PROJECT.
- 2. PRIOR TO START OF CONSTRUCTION AND THROUGH PROJECT COMPLETION, THE CONTRACTOR SHALL REMAIN IN FULL COMPLIANCE WITH CURRENT FEDERAL, STATE, AND LOCAL OCCUPATIONAL HEALTH AND SAFETY REGULATIONS.
- 3. ALL WORK SHALL CONFORM TO THE LATEST STANDARD "SPECIFICATIONS FOR PUBLIC WORKS CONSTRUCTION" AS ADOPTED BY THE CITY, COUNTY OR STATE AND AS MODIFIED BY STANDARD PLANS AND ADDENDUMS.
- 4. ALL UTILITIES AND OTHER FACILITIES DEPICTED ON THE PLANS ARE BASED ON A SEARCH OF AVAILABLE RECORDS AND FIELD OBSERVATIONS. THE CONTRACTOR SHALL VERIFY PRIOR TO CONSTRUCTION START AND USE EXTREME CARE AND PROTECTIVE MEASURES TO AVOID DAMAGE TO ANY FACILITIES WETHER OR NOT INDICATED ON THESE PLANS. THE CONTRACTOR IS RESPONSIBLE FOR THE PROTECTION OF ALL FACILITIES WITHIN THE LIMITS OF WORK, WHETHER OR NOT DEPICTED ONT THESE PLANS.
- 5. THE CONTRACTOR SHALL BE RESPONSIBLE FOR NOTIFICATION OF ANY CITY, COUNTY OR STATE ENGINEER INSPECTION DEPARTMENT A MINIMUM TWO DAYS PRIOR TO COMMENCEMENT OF ACTIVITY REQUIRING THEIR INVOLVEMENT.
- 6. THE EXPIRATION OF THE PERMIT FOR THIS PROJECT SHALL BE SPECIFIED BY THE LOCAL AUTHORITY HAVING JURISDICTION.
- 7. ALL UNDERGROUND CONDUITS PLACED AS PART OF THIS PROJECT MUST HAVE A MINIMUM COVER OF 48 INCHES UNLESS OTHERWISE APPROVED.
- 8. THE CONTRACTOR SHALL TUNNEL ALL CURB AND GUTTERS AND BORE ALL CONCRETE DRIVEWAYS AND WALKWAYS AT THE DIRECTION OF THE CITY, COUNTY OR STATE ENGINEER HAVING JURISDICTION.
- 9. ALL PAVEMENT CUT OR DAMAGED AS PART OF THIS PROJECT SHALL BE REPLACED AT THE DIRECTION OF THE CITY, COUNTY OR STATE ENGINEER HAVING JURISDICTION.
- 10. ALL SHRUBS, PLANTS OR TREES DAMAGED OR DISTURBED DURING THE COURSE OF THE WORK, SHALL BE REPLANTED AND/OR REPLACED SO AS TO RESTORE THE WORK SITE TO ITS ORIGINAL CONDITION.
- 11. THE CONTRACTOR SHALL BE RESPONSIBLE FOR PROCESSING OF ALL APPLICANT PERMIT FORMS ALONG WITH REQUIRED LIABILITY INSURANCE FORMS CLEARLY DEMONSTRATING OWNER, OWNER REPRESENTATIVES, ENGINEER, AND CITY, COUNTY OR STATE ARE ALSO INSURED WITH THE REQUIRED LIABILITY INSURANCE FOR THIS CONSTRUCTION PROJECT.
- 12. ALL SUBSURFACE STRUCTURES INCLUDING BUT NOT LIMITED TO VAULTS, PEDESTALS, AND CONDUITS SHALL BE AS SPECIFIED IN THESE PLANS OR AS SPECIFIED BY THE ENGINEER. ANY DEVIATIONS SHALL BE APPROVED BY THE ENGINEER IN WRITING PRIOR TO INSTALLATION.
- 13. THE CONTRACTOR IS RESPONSIBLE FOR VERIFICATION OF ALL EXISTING UTILITIES, INCLUDING BUT NOT LIMITED TO SEWER LATERALS AND WATER SERVICES, BOTH VERTICAL AND HORIZONTAL, PRIOR TO COMMENCING IMPROVEMENT OPERATIONS.
- 14. THE CONTRACTOR IS RESPONSIBLE FOR COMPLETION OF EXPLORATION EXCAVATIONS CONDUCTED FOR THE PURPOSE OF LOCATING EXISTING FACILITIES SUFFICIENTLY AHEAD OF CONSTRUCTION TO PERMIT REVISIONS TO PLANS AS REQUIRED.
- 15. LOCATIONS OF EXISTING UTILITIES ON THESE PLANS ARE BASED UPON EXISTING RECORDS VERIFIED WHERE POSSIBLE WITH FIELD TIES. CONTRACTOR IS RESPONSIBLE FOR VERIFICATION OF LOCATIONS SHOWN, BOTH HORIZONTAL AND VERTICALLY. PRIOR TO CONSTRUCTION, SUBSTANTIAL VARIANCES FROM THE PLANS SHALL BE COMMUNICATED TO THE ENGINEER TO FACILITATE CHANGES TO CONSTRUCTION DRAWINGS AS REQUIRED.

#### EROSION AND SEDIMENT CONTROL NOTES

TEMPORARY EROSION/SEDIMENT CONTROL PRIOR TO COMPLETION OF FINAL IMPROVEMENTS SHALL BE INSTALLED BY CONTRACTOR OR QUALIFIED PERSON AS INDICATED BELOW:

- 1. ALL REQUIREMENTS OF THE CITY, COUNTY AND STATE "STORM WATER STANDARDS" MUST BE INCORPORATED INTO THE DESIGN AND CONSTRUCTION OF THE PROPOSED GRADING/IMPROVEMENTS CONSISTENT WITH THE APPROVED STORM WATER POLLUTION PREVENTION PLAN (SWPPP), WATER QUALITY TECHNICAL REPORT (WQTR), AND/ OR WATER POLLUTION CONTROL PLAN (WPCP).
- 2. A GRAVEL BAG SILT BASIN SHALL BE INSTALLED IMMEDIATELY UPSTREAM OF STORM DRAIN INLETS AS INDICATED ON DETAILS.
- 3. FOR INLETS LOCATED AT SUMPS ADJACENT TO TOP OF SLOPES. THE CONTRACTOR SHALL INSURE WATER DRAINING TO THE SUMP IS DIRECTED INTO THE INLET AND A MINIMUM OF 1.00' FREEBOARD EXISTS AND IS MAINTAINED ABOVE THE TOP OF THE INLET. IF FREEBOARD IS NOT PROVIDED BY GRADING SHOWN ON THESE PLANS THE CONTRACTOR SHALL PROVIDE IT VIA TEMPORARY MEASURES, I.E. GRAVEL BAGS OR DIKES.
- 4. THE CONTRACTOR OR QUALIFIED PERSON SHALL BE RESPONSIBLE FOR CLEANUP OF SILT AND MUD ON ADJACENT STREET(S) AND STORM DRAIN SYSTEM DUE TO CONSTRUCTION ACTIVITY.
- 5. THE CONTRACTOR OR QUALIFIED PERSON SHALL CHECK AND MAINTAIN ALL LINED AND UNLINED DITCHES AFTER EACH RAINFALL.
- 6. THE CONTRACTOR SHALL REMOVE SILT AND DEBRIS AFTER EACH MAJOR RAINFALL.
- 7. THE CONTRACTOR SHALL MAINTAIN EQUIPMENT AND WORKERS FOR EMERGENCY WORK AT ALL TIMES DURING THE RAINY SEASON. MATERIALS NECESSARY FOR EMERGENCY MEASURES SHALL BE STOCKPILED ON SITE AT CONVENIENT LOCATIONS TO FACILITATE RAPID CONSTRUCTION OF TEMPORARY DEVICES WHEN RAIN IS IMMINENT.
- 8. THE CONTRACTOR IS RESPONSIBLE FOR RESTORING ALL EROSION/SEDIMENT CONTROL DEVICES TO WORKING ORDER TO THE SATISFACTION OF THE CITY/COUNTY/STATE ENGINEER OR RESIDENT ENGINEER FOLLOWING ANY RUN-OFF PRODUCING RAINFALL.
- 9. THE CONTRACTOR SHALL INSTALL ADDITIONAL EROSION/SEDIMENT CONTROL MEASURES AS REQUIRED BY THE RESIDENT ENGINEER DUE TO UNCOMPLETED GRADING OPERATIONS OR UNFORESEEN CIRCUMSTANCES.
- 10. THE CONTRACTOR SHALL BE RESPONSIBLE AND TAKE NECESSARY PRECAUTIONS TO PREVENT PUBLIC TRESPASS ONTO AREAS WHERE IMPOUNDED WATERS CREATE A HAZARDOUS CONDITION.
- 11. ALL EROSION/SEDIMENT CONTROL MEASURES PROVIDED PER THE APPROVED GRADING PLAN SHALL BE INCORPORATED HERON. ALL EROSION/SEDIMENT CONTROL FOR INTERIM CONDITIONS SHALL BE DONE TO THE SATISFACTION OF THE RESIDENT ENGINEER.
- 12. UPON COMPLETION OF WORK EACH DAY, GRADED AREAS AROUND THE PROJECT PERIMETER MUST DRAIN AWAY FROM THE FACE OF THE
- 13. ALL REMOVABLE PROTECTIVE DEVICES SHOWN SHALL BE IN PLACE AT THE END OF EACH WORKING DAY WHEN RAIN IS IMMINENT.
- 14. GRADING, INCLUDING CLEARING AND GRUBBING SHALL ONLY BE CONDUCTED IN AREAS WHERE THE CONTRACTOR OR QUALIFIED PERSON CAN PROVIDE EROSION/SEDIMENT CONTROL MEASURES.

#### ROW GROUND CONSTRUCTION NOTES:

- 1. THE CONTRACTOR SHALL REMOVE/CLEAN ALL DEBRIS, NAILS, STAPLES, OR NON-USED
- VERTICALS OFF THE POLE.
- 2. ALL WORK SHALL BE IN ACCORDANCE WITH MUNICIPAL, COUNTY, STATE, AND FEDERAL

#### STANDARDS AND REGULATIONS.

- 3. THE CONTRACTOR SHALL CALL LOCAL UNDERGROUND LOCATE SERVICE THREE WORKING DAYS
- BEFORE ANY CONSTRUCTION IS STARTED
- 4. ALL EXISTING LANDSCAPING SHALL BE RESTORED TO ORIGINAL OR BETTER CONDITION.
- 5. ALL EQUIPMENT SHALL BE BONDED.
- 6. IF A METERING CABINET IS INSTALLED, A MINIMUM 3' CLEARANCE IS REQUIRED AT DOOR OPENING.
- 7. IF A METERING CABINET IS INSTALLED, THE CONTRACTOR SHALL CAULK THE CABINET BASE AT THE PAD.

#### STANDARD GROUNDING NOTES:

- 1. GROUND SHALL BE TESTED AT 25 OHMS OR LESS.
- 2. GROUND RODS SHALL BE 5/8"X8'. ATTACHMENT TO GROUND RODS SHALL BE EXOTHERMIC WELD OR UL LISTED DIRECT BURY CLAMP BELOW GRADF.
- 3. BURIED GROUND AND BONDING WIRE SHALL BE #6 AWG.
- 4. MOLDING SHALL BE STAPLED EVERY 1' AND AT EACH END.

#### STANDARD CONDUIT NOTES:

- 1. SCHEDULE 40 CONDUIT SHALL BE USED UNDERGROUND.
- 2. SCHEDULE 80 CONDUIT SHALL BE USED FOR RISERS.
- 3. RISERS SHALL BE ATTACHED TO POLE WITH STANDARD U-CLAMPS AND LAG SCREWS.
- 4. RISER U-CLAMPS TO BE INSTALLED EVERY 5'.
- 5. FOR U/G POWER INSTALLATIONS, 2" SDR-11 RED CONDUIT SHALL BE UTILIZED.
- 6. GROUND WIRE MOLDING STAPLES MAY BE BE UTILIZED FOR ATTACHING CONDUIT LESS THAN 1" DIAMETER.
- 7. ALL CONDUIT SHALL BE PROOFED WITH A MANDREL AND EQUIPPED WITH A PULL ROPE OR MULE TAPE.

#### STANDARD TRENCHING NOTES:

- 1. A MINIMUM OF 2'-6" OF COVER SHALL BE MAINTAINED OVER ALL ELECTRICAL CONDUITS.
- 2. A MINIMUM OF 4'-0" OF COVER SHALL BE MAINTAINED OVER ALL COMMUNICATIONS CONDUITS.
- 3. IN STREETS, SLURRY TO GRADE AND MILL DOWN 1-1/2" FOR AC CAP.
- 4. IN DIRT, SLURRY TO 18" FROM GRADE AND FILL WITH 95% COMPACTION NATIVE SOIL FOR BALANCE.
- 5. WARNING TAPE SHALL BE INSTALLED 1'-O" ABOVE ALL CONDUITS. #18 WARNING TAPE SHALL BE INSTALLED ABOVE GROUND RING.

#### ROW UTILITY POLE CONSTRUCTION NOTES:

- 1. BOLT THREADS SHALL NOT PROTRUDE MORE THAN 1-1/2".
- 2. HOLES LEFT IN POLE DUE TO REARRANGEMENT OF CLIMBERS SHALL BE FILLED.
- 3. CLIMB STEPS ADJACENT TO CONDUIT SHALL HAVE EXTENDED STEPS.
- 4. CABLE SHALL NOT IMPEDE 15" CLEAR SPACE OFF POLE FACE (12:00).
- 5. 90° SHORT SWEEPS SHALL BE USED UNDER ANTENNA ARM. CABLES MUST TRANSITION ON THE INSIDE OR BOTTOM OF ARMS. (NO CABLE SHALL BE INSTALLED ON TOP OF ARMS.)
- 6. CABLE CLAMPS SHALL BE UTILIZED TO SECURE CABLE TO
  ARMS; 2" CARRIER CABLE ID TAGS SHALL BE PLACED ON BOTH SIDES OF
- 7. UTILIZE A 90° CONNECTOR AT CABLE CONNECTION TO ANTENNA.
- 8. 1/2" CABLE TO BE UTILIZED UNLESS NOTED OTHERWISE.
- 9. VOIDS AROUND CABLES AT CONDUIT OPENINGS SHALL BE FILLED WITH FOAM SEALANT TO PREVENT WATER INTRUSION.







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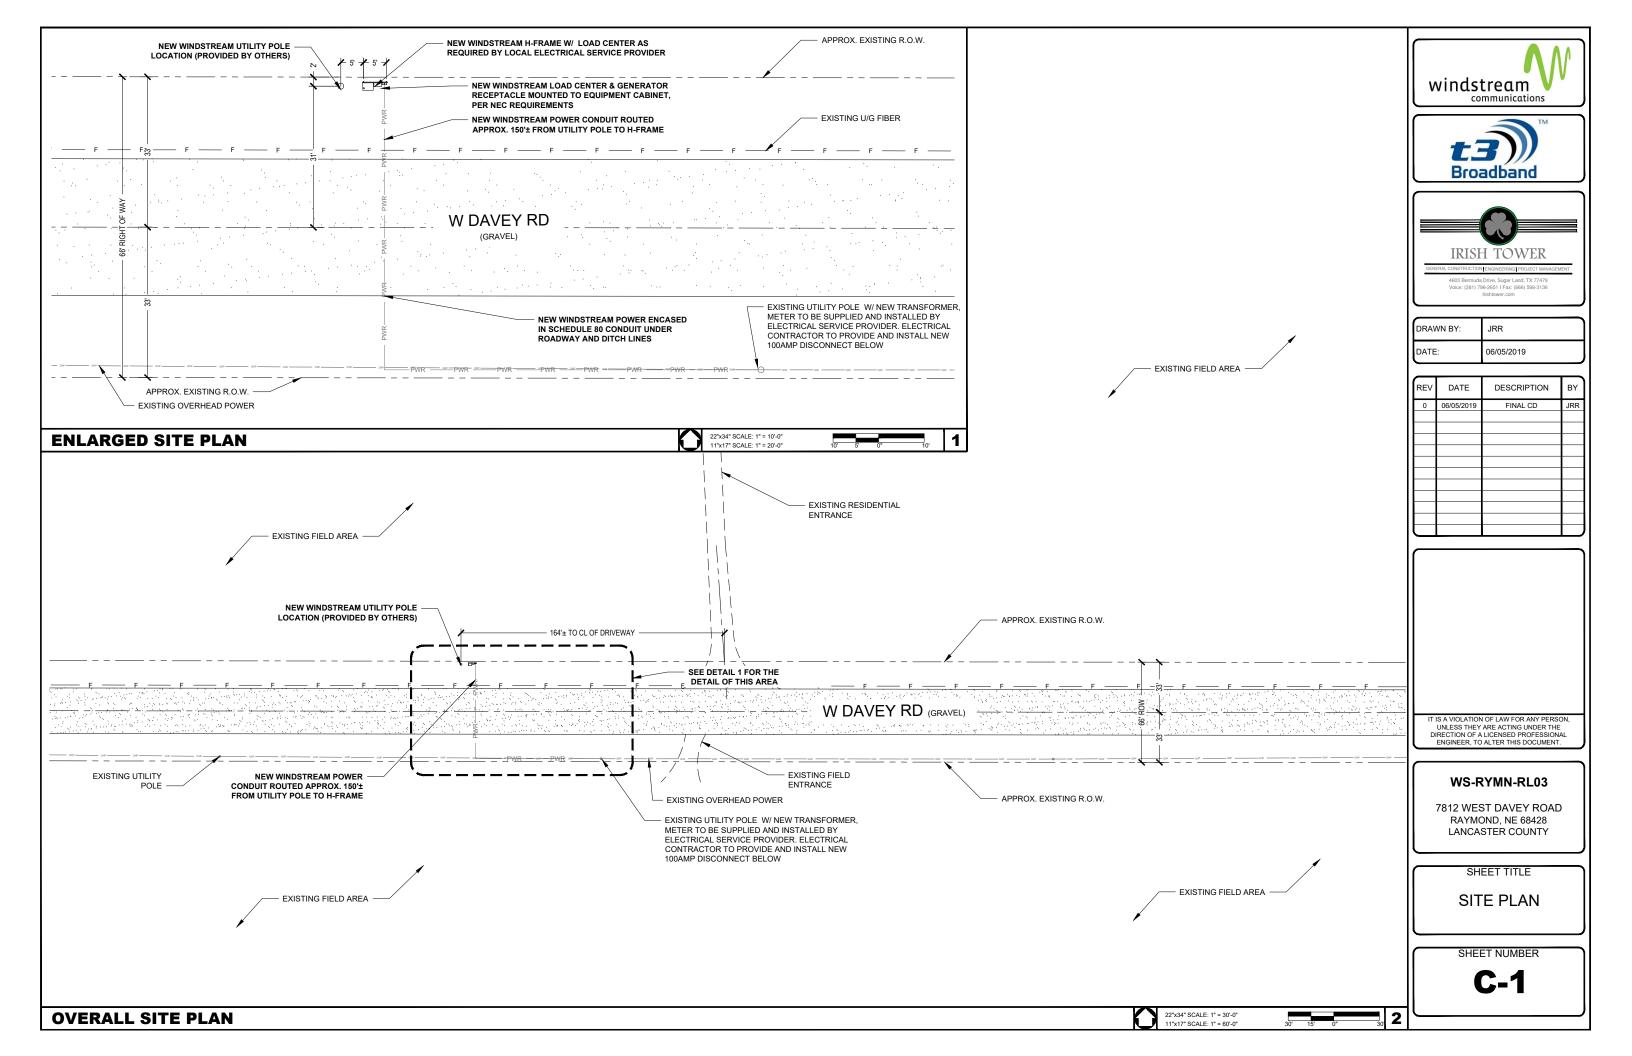
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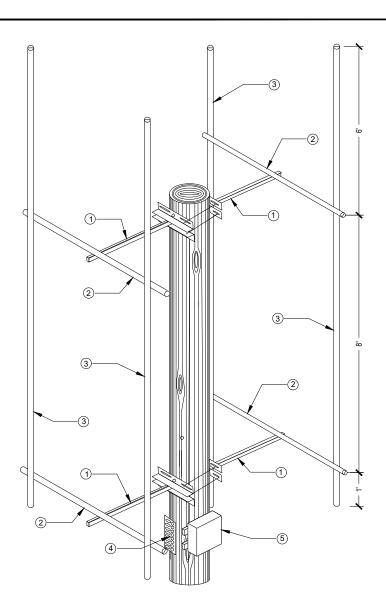
#### WS-RYMN-RL03

7812 WEST DAVEY ROAD RAYMOND, NE 68428 LANCASTER COUNTY


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- 1 FOUR 2.5' WOOD POLE STAND-OFFS, TWO MOUNTED BACK-TO-BACK AT 99', ONE AT 45° AND ONE AT 225° EACH SECURED TO THE POLE WITH TWO 4" GALVANIZED LAG BOLTS. THE STAND-OFFS WILL BE CONNECT TO EACH OTHER WITH FOUR 5/8" ALL-THREAD AND GALVANIZED HARDWARE. THE OTHER TWO WOOD POLE STAND-OFFS WILL BE MOUNTED AN 91' IN THE SAME MANNER AS THE TOP STAND-OFFS.
- 2) HORIZONTAL PIPE: FOUR 1.66" OD X 5' LONG PIPES (MADE BY CUTTING A 10' LENGTHS OF PIPE IN HALF) WILL BE MOUNTED ONE EACH TO EACH OF THE FOUR 2.5' WOOD POLE STAND-OFF MOUNTS INSTALLED IN THE PREVIOUS STEP. THE CENTER OF EACH HORIZONTAL PIPE SHOULD ATTACH TO END OF EACH OF THE STAND-OFF MOUNTS UTILIZING A PIPE CROSSOVER MOUNT (PN-SINCLAMPO17) TO MAKE THE CONNECTION.
- ③ VERTICAL PIPES: FOUR VERTICAL 1.66" OD X 15'GALVANIZED PIPES ARE USED TO COMPLETE THE POLE TOP MOUNT. ONE EACH OF THE VERTICAL PIPES WILL ATTACH TO THE ENDS OF THE UPPER AND LOWER HORIZONTAL PIPES. EACH VERTICAL PIPE SHOULD ATTACH 2" IN FROM THE END OF THE HORIZONTAL PIPES WITH ~6' OF PIPE EXTENDING ABOVE THE UPPER HORIZONTAL PIPE AND ~12" OF PIPE EXTENDING BELOW THE LOWER HORIZONTAL PIPE. EACH VERTICAL PIPE WILL BE CONNECTED TO THE HORIZONTAL PIPES WITH TWO PIPE CROSS-OVER MOUNTS (PNSINCLAMPO17) ONE ON THE TOP HORIZONTAL PIPE AND ONE ON THE BOTTOM.
  DURING FINAL ASSEMBLE A LEVEL SHOULD BE USED TO ASSURE THAT THE VERTICAL PIPES ARE INSTALL PLUMB IN EACH DIRECTION.
- 4 PTMP RAD CENTER GROUND BAR SHOULD BE ATTACHED TO THE POLE UTILIZING THE INCLUDED ISOLATION MOUNTS AND HARDWARE, 12" BELOW THE BOTTOM 2.5' STAND-OFF MOUNTS.
- (5) PTMP RAD CENTER OUTDOOR ENCLOSURE (PN-AM32P-2625-16RU) SHOULD BE ATTACHED TO THE POLE 1' ABOVE THE BOTTOM MOUNT. A 16" UNISTRUT SHOULD BE SECURED TO THE POLE USING A 4" GALVANIZED LAG BOT. THE ENCLOSURE SHOULD BE MOUNTED TO THE UNISTRUT UTILIZING THE SPRING NUT AND BOLT



STRUCTURAL NOTE:

. PROJECT OWNER IS RESPONSIBLE FOR PROVIDING A GLOBAL/LOCAL STRUCTURAL ANALYSIS OF EQUIPMENT ANCHORS, SUPPORTS AND DESIGN/DETAILING OF ANY STRUCTURAL MODIFICATIONS/REINFORCEMENT REQUIRED

2. THIS DOCUMENT IS FOR PERMITTING ONLY AND IS NOT INTENDED FOR CONSTRUCTION UNLESS ACCOMPANIED BY A PE STAMPED/SIGNED STRUCTURAL ASSESSMENT/ANALYSIS REPORT AS PROVIDED BY THE PROJECT OWNER.

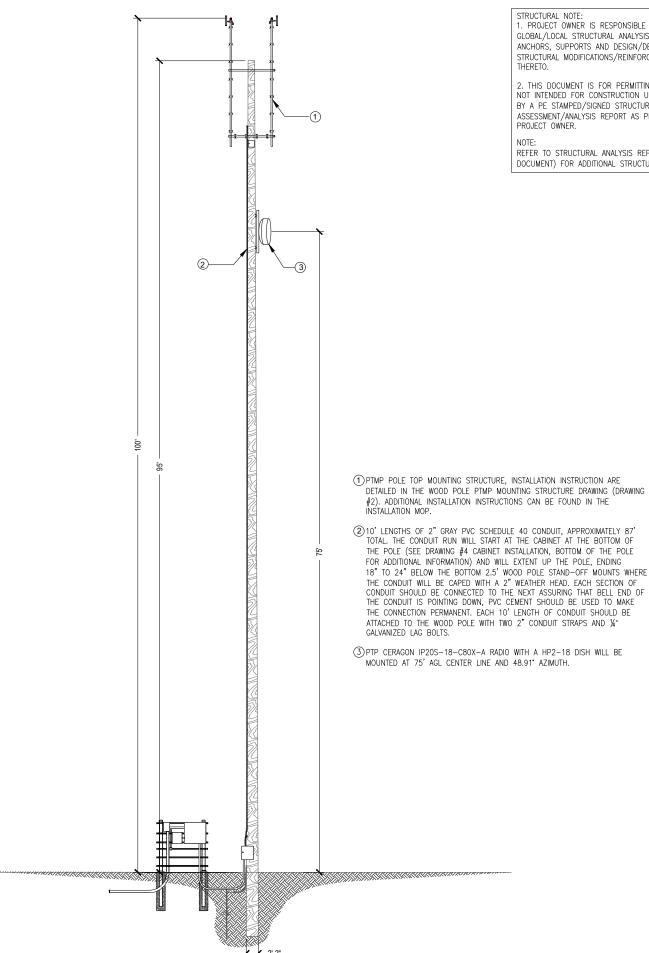REFER TO STRUCTURAL ANALYSIS REPORT (SEPARATE DOCUMENT) FOR ADDITIONAL STRUCTURAL INFORMATION.







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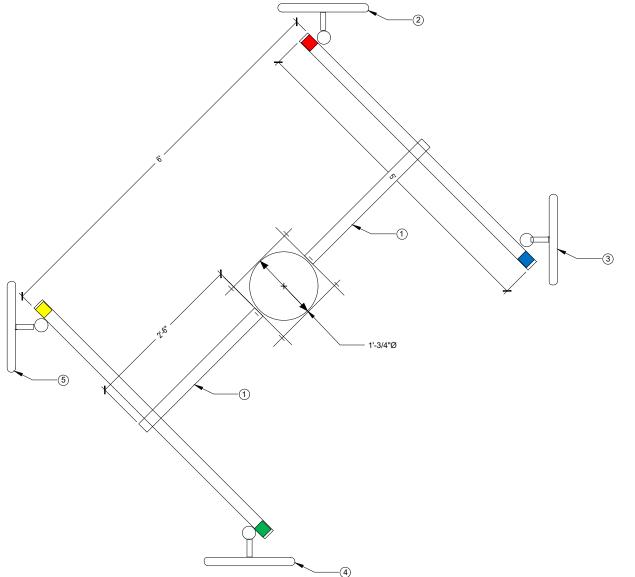
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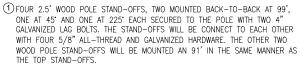
#### WS-RYMN-RL03

7812 WEST DAVEY ROAD RAYMOND, NE 68428 LANCASTER COUNTY

> SHEET TITLE **ELEVATION DETAILS**

SHEET NUMBER





- 2 AZIMUTH 01 (0° NORTH) HAS A SINGLE BS AT 99'ACL, 0° AZIMUTH WITH 0° PHYSICAL DOWN TILT AND PROVISIONED WITH A 40 MHZ WIDE CHANNEL IN THE 5.8 GHZ RANGE (SEE RFDS FOR SPECIFIC FREQUENCY. AZIMUTH 01 (NORTH) IS LABELED WITH RED TAPE, THE TOP OF THE PIPE IS MARKED WITH A SINGLE WRAP OF RED TAPE. THE BS SHOULD HAVE A SINGLE WRAP OF RED TAPE ON EACH END OF THE FOLLOWING CABLES; THE JUMPER CABLE BETWEEN THE LPU AND THE BS, THE VERTICAL CABLE RUN BETWEEN THE TOP LPU AND THE BOTTOM LPU AND THE JUMPER BETWEEN THE BOTTOM LPU AND THE BOTTO POF SWITCH PORT
- (3) AZIMUTH 02 (90° EAST) HAS A SINGLE BS AT 99'ACL, 90° AZIMUTH WITH O' PHYSICAL DOWN TILT AND PROVISIONED WITH A 40 MHZ WIDE CHANNEL IN THE 5.8 GHZ RANGE (SEE RFDS FOR SPECIFIC FREQUENCY. AZIMUTH 02 (EAST) IS LABELED WITH BLUE TAPE, THE TOP OF THE PIPE IS MARKED WITH A SINGLE WRAP OF BLUE TAPE. THE BS SHOULD HAVE A SINGLE WRAP OF BLUE TAPE ON EACH END OF THE FOLLOWING CABLES; THE JUMPER CABLE BETWEEN THE LPU AND THE BS, THE VERTICAL CABLE RUN BETWEEN THE TOP LPU AND THE BOTTOM LPU AND THE JUMPER BETWEEN THE BOTTOM LPU AND POE SWITCH PORT.
- 4 AZIMUTH 03 (180' SOUTH) HAS A SINGLE BS AT 99'ACL, 180' AZIMUTH WITH O' PHYSICAL DOWN TILT AND PROVISIONED WITH A 40 MHZ WIDE CHANNEL IN THE 5.8 GHZ RANGE (SEE RFDS FOR SPECIFIC FREQUENCY. AZIMUTH 03 (SOUTH) IS LABELED WITH GREEN TAPE, THE TOP OF THE PIPE IS MARKED WITH A SINGLE WRAP OF GREEN TAPE. THE BS SHOULD HAVE A SINGLE WRAP OF GREEN TAPE ON EACH END OF THE FOLLOWING CABLES; THE JUMPER CABLE BETWEEN THE LPU AND THE BS, THE VERTICAL CABLE RUN BETWEEN THE TOP LPU AND THE BOTTOM LPU AND THE JUMPER BETWEEN THE BOTTOM LPU AND POE SWITCH PORT.
- (5) AZIMUTH 04 (270° WEST) HAS A SINGLE BS AT 99'ACL, 270° AZIMUTH WITH O' PHYSICAL DOWN TILT AND PROVISIONED WITH A 40 MHZ WIDE CHANNEL IN THE 5.8 GHZ RANGE (SEE RFDS FOR SPECIFIC FREQUENCY, AZIMUTH 0.3 (SOUTH) IS LABELED WITH YELLOW TAPE, THE TOP OF THE PIPE IS MARKED WITH A SINGLE WRAP OF YELLOW TAPE. THE BS SHOULD HAVE A SINGLE WRAP OF YELLOW TAPE ON EACH END OF THE FOLLOWING CABLES; THE JUMPER CABLE BETWEEN THE LPU AND THE BS, THE VERTICAL CABLE RUN BETWEEN THE TOP LPU AND THE BOTTOM LPU AND THE JUMPER BETWEEN THE BOTTOM LPU AND POE SWITCH PORT.







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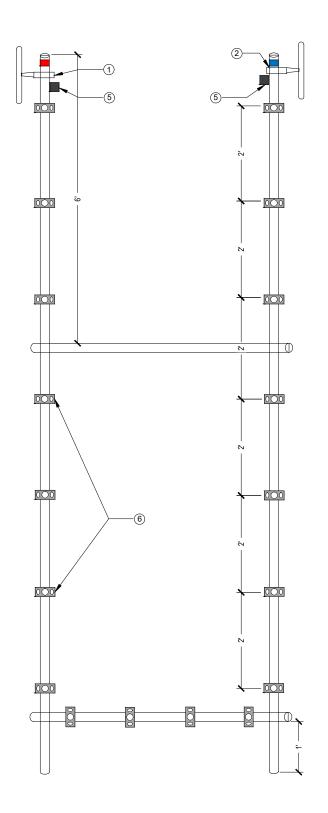
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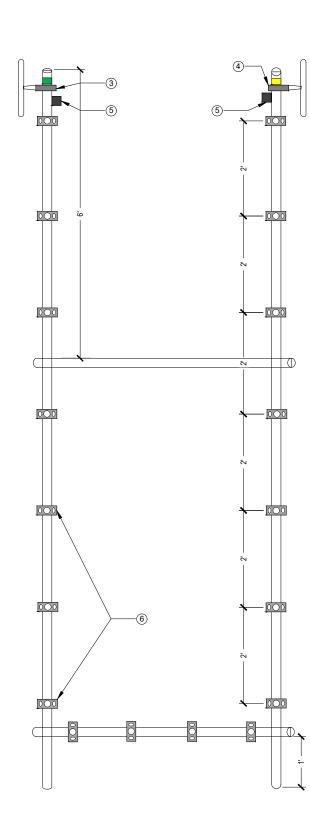
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7812 WEST DAVEY ROAD RAYMOND, NE 68428 LANCASTER COUNTY

SHEET TITLE ANTENNA LAYOUT **DETAILS** 

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- ① AZIMUTH 01 (0' NORTH) HAS A SINGLE BS AT 99'ACL, 0' AZIMUTH WITH 0' PHYSICAL DOWN TILT AND PROVISIONED WITH A 40 MHZ WIDE CHANNEL IN THE 5.8 GHZ RANGE. AZIMUTH 01 IS LABELED WITH RED TAPE, THE TOP OF THE PIPE IS MARKED WITH A SINGLE WRAP OF RED TAPE. THE BS SHOULD HAVE A SINGLE WRAP OF RED TAPE ON EACH END OF THE FOLLOWING CABLES; THE JUMPER CABLE BETWEEN THE LPU AND THE BS, THE VERTICAL CABLE RUN BETWEEN THE TOP LPU AND THE BOTTOM LPU AND THE JUMPER BETWEEN THE BOTTOM LPU AND POE SWITCH PORT.
- (2) AZIMUTH 02 (90° EAST) HAS A SINGLE BS AT 99'ACL, 90° AZIMUTH WITH 0' PHYSICAL DOWN TILT AND PROVISIONED WITH A 40 MHZ WIDE CHANNEL IN THE 5.8 GHZ RANGE. AZIMUTH 02 IS LABELED WITH BLUE TAPE, THE TOP OF THE PIPE IS MARKED WITH A SINGLE WRAP OF BLUE TAPE. THE BS SHOULD HAVE A SINGLE WRAP OF BLUE TAPE ON EACH END OF THE FOLLOWING CABLES; THE JUMPER CABLE BETWEEN THE LPU AND THE BS, THE VERTICAL CABLE RUN BETWEEN THE TOP LPU AND THE BOTTOM LPU AND THE JUMPER BETWEEN THE BOTTOM LPU AND POE SWITCH PORT.
- (3) AZIMUTH 03 (180° SOUTH) HAS A SINGLE BS AT 99'ACL, 180° AZIMUTH WITH 0° PHYSICAL DOWN TILT AND PROVISIONED WITH A 40 MHZ WIDE CHANNEL IN THE 5.8 GHZ RANGE. AZIMUTH 03 IS LABELED WITH GREEN TAPE, THE TOP 0F THE PIPE IS MARKED WITH A SINGLE WRAP OF GREEN TAPE. THE BS SHOULD HAVE A SINGLE WRAP OF GREEN TAPE ON EACH END OF THE FOLLOWING CABLES; THE JUMPER CABLE BETWEEN THE LPU AND THE BS, THE VERTICAL CABLE RUN BETWEEN THE TOP LPU AND THE BOTTOM LPU AND THE JUMPER BETWEEN THE BOTTOM LPU AND POE SWITCH PORT.
- (4) AZIMUTH 04 (270' WEST) HAS A SINGLE BS AT 99'ACL, 270' AZIMUTH WITH 0' PHYSICAL DOWN TILT AND PROVISIONED WITH A 40 MHZ WIDE CHANNEL IN THE 5.8 CHZ RANGE. AZIMUTH 03 IS LABELED WITH YELLOW TAPE, THE TOP OF THE PIPE IS MARKED WITH A SINGLE WRAP OF YELLOW TAPE. THE BS SHOULD HAVE A SINGLE WRAP OF YELLOW TAPE ON EACH END OF THE FOLLOWING CABLES; THE JUMPER CABLE BETWEEN THE LPU AND THE BS, THE VERTICAL CABLE RUN BETWEEN THE TOP LPU AND THE BOTTOM LPU AND THE JUMPER BETWEEN THE BOTTOM LPU AND POE SWITCH PORT.
- (5) POLE TOP LIGHTNING PROTECTION UNITS (LPU): EACH BASE STATION WILL HAVE ONE POLE TOP LPU MOUNTED 2" BELOW THE BS MOUNTING CLAMP 180' OPPOSITE THE BS. FOLLOW THE CABLE INSTALLATION INSTRUCTIONS INCLUDED WITH THE LPU WHEN CABLING THE LPU.
- (6) THREE HOLE UNIVERSAL SNAP—IN ADAPTORS SHOULD BE ATTACHED TO EACH OF THE VERTICAL PIPES EVERY 2', AND THE LOWER HORIZONTAL PIPE EVERY 1' TO ACCOMMODATE THE APPROPRIATE SNAP HANGERS AND GROMMETS FOR PROPER CABLE SUPPORT. NOTE: ALTHOUGH SHOWN IN THE PHOTO FOR ILLUSTRATIVE PURPOSES, VERTICAL PIPES WITHOUT BASE STATION SHOULD NOT HAVE UNIVERSAL SNAP—IN ADAPTORS INSTALLED.







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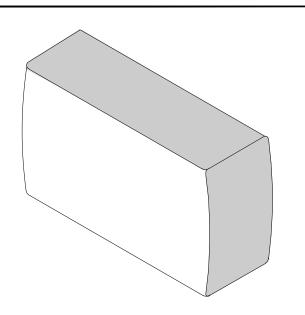
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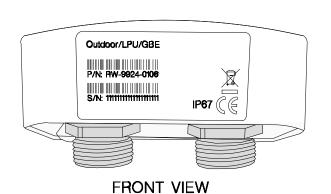
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**C-4** 

**NEW STRUCTURE DETAILS** 



	BAS	E STATION
ı	MANUF:	RADWIN
ı	PART #:	RW-5BG5-0649
ı	HEIGHT:	8.86"
ı	WIDTH:	14.01"
ı	DEPTH:	3.7"
l	WEIGHT:	7.28 LBS



LIGHTNING PROTECTION		
MANUF:	RADWIN	
PART #:	RW-9924-0106	
HEIGHT:	2.04"	
WIDTH:	3.87"	
DEPTH:	1.88"	
WEIGHT:	0.49 LBS	



	С	ABINET
1	MANUF:	WESTELL
1	PART #:	BXM1019-NHE3
1	HEIGHT:	22.5"
1	WIDTH:	25.5"
1	DEPTH:	27.8"
ı	WEIGHT:	70.00 LBS







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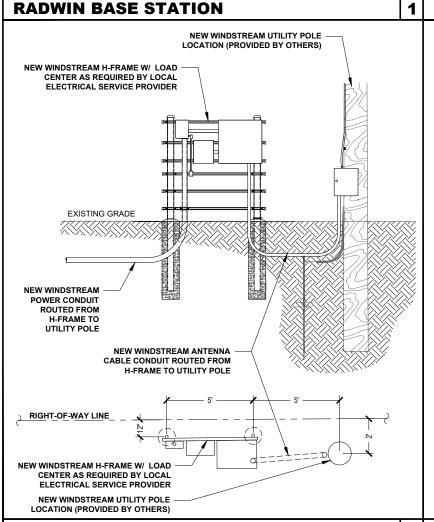
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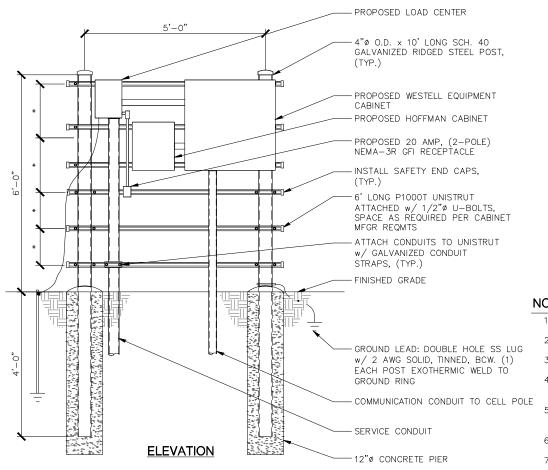
# LIGHTNING PROTECTOR

H-FRAME DETAIL

# **WESTELL BOXER OUTDOOR CABINET**





**DETAIL RACK ELEVATION** 



NOTES: 1. \*- COORDINATE ELEVATIONS WITH EQUIPMENT/MOUNTING HEIGHT. 2. STEEL SHALL BE HOT DIP GALVANIZED.

- 3. CABINETS SHALL BE MOUNTED WITH STAINLESS STEEL BOLTS.
- 4. METAL POSTS ARE NOT ALLOWED TO SERVE AS EQUIPMENT GROUNDING CONDUCTOR.
- 5. UNISTRUT SHALL NOT EXTEND BEYOND POST & MUST HAVE SAFETY END CAPS FOR SAFETY REASONS.
- 6. METALLIC PARTS SHALL BE BONDED ACCORDING TO THE NEC.
- 7. GROUNDING SHALL CONFORM TO NEC AND SECTION 436-439.

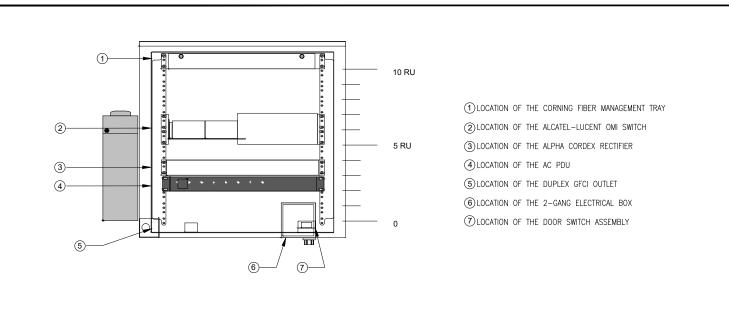

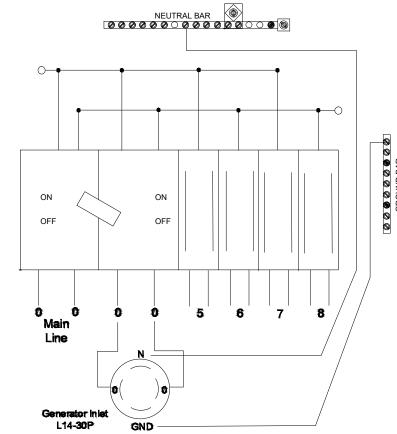







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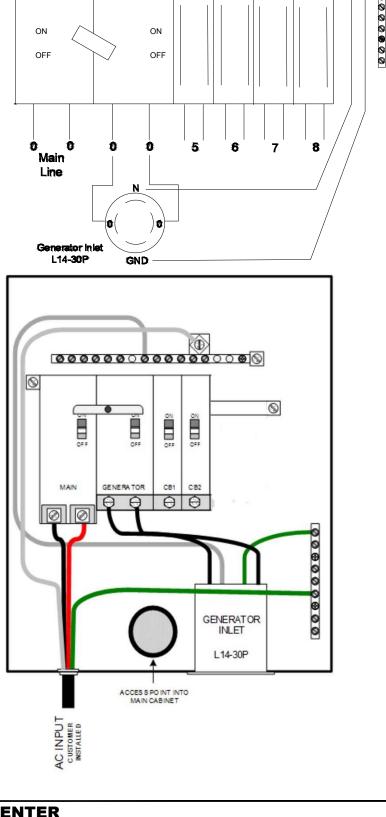
7812 WEST DAVEY ROAD RAYMOND, NE 68428 LANCASTER COUNTY

SHEET TITLE **ELECTRICAL &** GROUNDING **DETAILS** 

SHEET NUMBER

3

**E-1** 



**NOT USED** 

**CABINET DETAIL** 

2 LOAD CENTER